

# Meriden-Markham Municipal Airport City of Meriden, Connecticut

## Contract Plans For:


# **RUNWAY 18-36 REHABILITATION**





City of Meriden Contract No. B021-33 FAA AIP NO. 3-09-0012-02X-2021 Stantec Project No. 179450289 APRIL 7, 2021



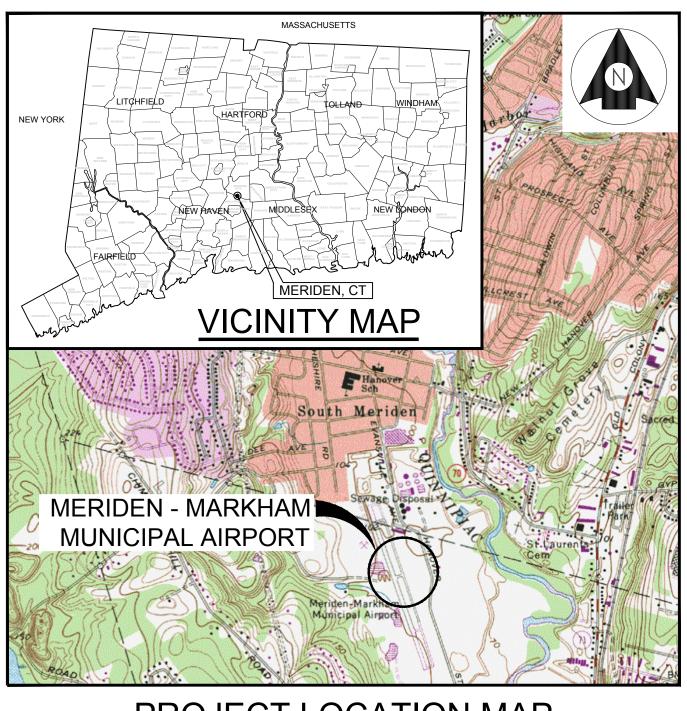

**PROJECT LOCATION MAP** NOT TO SCALE

## INDEX OF DRAWINGS

DRAWING NO.	TITLE
– G.001 G.002	COVER SHEET WORK SUMMARY AND DETAILS CONSTRUCTION ACCESS AND SAFETY PLAN
C.118	DEMOLITION PLAN – SHEET 1 OF 3 DEMOLITION PLAN – SHEET 2 OF 3 DEMOLITION PLAN – SHEET 3 OF 3 PAVEMENT LAYOUT PLAN – SHEET 1 OF 3 PAVEMENT LAYOUT PLAN – SHEET 2 OF 3 PAVEMENT LAYOUT PLAN – SHEET 3 OF 3 GRADING PLAN – SHEET 1 OF 3 GRADING PLAN – SHEET 2 OF 3 GRADING PLAN – SHEET 3 OF 3 RUNWAY 18–36 CENTERLINE PROFILE TAXIWAY CENTERLINE PROFILES TYPICAL SECTIONS PAVEMENT MARKING PLAN – SHEET 1 OF 3 PAVEMENT MARKING PLAN – SHEET 2 OF 3 PAVEMENT MARKING PLAN – SHEET 3 OF 3
E.001 E.300 E.301 E.302 E.500 E.501 E.502	ELECTRICAL LEGEND AND GENERAL NOTES ELECTRICAL LAYOUT PLAN – SHEET 1 OF 3 ELECTRICAL LAYOUT PLAN – SHEET 2 OF 3 ELECTRICAL LAYOUT PLAN – SHEET 3 OF 3 ELECTRICAL DETAILS – SHEET 1 OF 3 ELECTRICAL DETAILS – SHEET 2 OF 3 ELECTRICAL DETAILS – SHEET 3 OF 3
ADD 1A ADD 1B	ADD ALTERNATE No. 1 TAXIWAY A, MILL AND OVERLAY – SHEET 1 OF 2 ADD ALTERNATE No. 1 TAXIWAY A, MILL AND OVERLAY – SHEET 2 OF 2

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1. 2.	SPECIFICATIONS REFER	RENCED THEREIN.	CCORDANCE WITH THE	CONTRACT PLANS AND		ARE REQUI NOTED ALO	RED. BARRICADES NG THE AFFECTED BARRICADES IN
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3.	CONSTRUCTION OF TH SHOWN ON THE PLAN	IS PROJECT. THE CONT S. ALL APRON AREAS A	ARE OFF LIMITS TO THE	TED TO THE WORK LIMITS CONTRACTOR.	15.	WORK. THE FOR ALL W THE SEQUE	N OF ALL PERSON WORK SHALL PR ORKERS INCLUDIN INCE OF OPERATION AT PERSONNEL AN
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5.	WHERE THEY WILL NO	T CONSTITUTE A HAZAR	D TO AIRCRAFT OPERAT	ED IN APPROVED AREAS TONS AND NOT PENETRATE ING AREA WHEN NOT IN	17	OR REMAIN AIRCRAFT (	, SUBCONTRACTOF IN ANY AIRPORT OPERATIONS. WING ARE CONSID
6.	CALL 911 THEN CONT		TY BREACHES, ETC.) TH AGER (203) 630–2878 S POSSIBLE.			TRENCHES,	HOLES, OR EXCA R TAXIWAY SAFETY
7.	INCLUDING THE PROJE PERSONNEL SHALL BE	CT SUPERINTENDENT W	IE NUMBERS (3) OF TH HO MAY BE CONTACTED PER DAY FOR MAINTAIN	IN AN EMERGENCY.		TAXILANE,	/UNLIGHTED HOLE OR RELATED SAFE
8.	LIGHTING AND BARRICA	THE SPECIFICATIONS, L	ABOR WAGE RATES SHA	ALL BE POSTED ON SITE IN		OR OTHER	R PILES OF EART OBJECTS IN THE ED SAFETY, APPRO
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		OR THIS PROJECT SHAL		JIDELINES SET FORTH IN DNAL SAFETY ON AIRPORTS	E.	COULD INT	EQUIPMENT, EXCA ERFERE WITH ELEC AL AIDS (NAVAIDS)
0	DURING CONSTRUCTION AND THESE PLANS AN	N", THE PROJÈCTS "COI ID SPECIFICATIONS.	NSTRUCTION SAFETY AN	D PHASING PLAN" (CSPP),	F.	CAUSE DAM	DROP-OFFS - LI IAGE TO AIRCRAFT DROP-OFF OR LIP
2.	SEVEN (7) DAYS PRIC SHALL BECOME KNOW	OR TO THE ISSUANCE O LEDGEABLE OF THE REC			G.	UNMARKED	UTILITY, NAVAID, BLES THAT COULD
3.	ACTIVITIES AND OPERA CONSTRUCTION ACTIVIT	TIONS THAT ARE INHER	ALL ROUTINE AND EMER	AND SHALL CONDUCT ITS	H.	THE VICINI	WHETHER OR NOT Y OF THE AIRPOR TO PILOTS DURING
4.	CONSTRUCTION ACTIVIT	TIES ARE NOT PERMITTE		AREA/OBJECT FREE AREA APPROVAL OF THE		THE LIKE A	
5.	IN ORDER FOR THE C APPROPRIATE NOTICES THROUGH THE FAA FL CLOSED, LIMITED, OR 48-HOUR NOTICE IS OPERATIONS MUST BE ISSUANCE. ONCE, ALL SAFETY DEVICES INCLU	TO AIRMEN (NOTAMS) IGHT SERVICE STATION HAZARDOUS CONDITION REQUIRED FOR ISSUANC CLOSELY COORDINATEE NOTAMS ARE IN PLACE	THESE NOTICES PROVI S TO AIRMEN AND USE CE OF THE NOTAM. ALL O WITH THE AIRPORT MA THE CONTRACTOR SHA O TO CONSTRUCTION SIG	THE AIRPORT MANAGER DE INFORMATION ON RS OF THE AIRPORT. A CONSTRUCTION ANAGER FOR NOTAM ALL SET UP CONSTRUCTION	19.	CONTAINED AREAS AS	ACTOR SHALL CO HEREIN. THE CO OFTEN AS NECES EMEDY ANY UNSA D.
6.	OPERATE WITHIN THE CONSTRUCTION AS DE 3' OR LARGER ORANG 1" SQUARE. WHEN OP CONTRACTOR'S VEHICL	SECURITY FENCE ON TH FINED HEREIN, SHALL E E AND WHITE CHECKER ERATING DURING PERIO ES SHALL BE EQUIPPEI	DISPLAY IN FULL VIEW A RBOARD FLAG, EACH CH DS OF DARKNESS OR L D WITH ROTATING OR F	DESIGNATED LIMITS OF ABOVE THE VEHICLE A 3' X ECKERBOARD COLOR BEING IMITED VISIBILITY, LASHING AMBER LIGHTS.			
7. 8.	AIRFIELD.		NG OR OPEN FLAMES C LOWED ON EXISTING PA	IN ANY PORTION OF THE			
9.	REMAIN. STOCKPILED MATERIAL	SHALL BE CONSTRAINE		REVENT MOVEMENT AS A			
10.	CONTRACTOR GENERAT CAPABLE OF CAUSING INGESTED IN JET ENG OR ADJACENT GRASSE	ED DEBRIS, WASTE, AN DAMAGE TO AIRCRAFT INES, SHALL NOT BE AI	D LOOSE MATERIAL (INC LANDING GEAR OR PRO LLOWED ON ACTIVE AIRC BSERVED TO BE WITHIN	CLUDING DUST AND DIRT)			
11.	CONTRACTORS ACCESS STRICTLY PROHIBITED.			ROJECT WORK LIMITS IS			
12.	THE CONTRACTOR SHA FLAGMAN AS REQUIRE ADJACENT ROADWAYS.	-	SIGNING IN ACCORDANG INCLUDING EQUIPMENT				
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VIDE, INSTALL AND MAINTAIN FLASHING LIGHTS AND BARRICADES OR IRREGULAR GRADES ARE LEFT WITHIN THE SAFETY AREA OF TEMPORARY PAVEMENT CLOSURES OR AIRCRAFT LIMITATIONS SHALL BE SPACED NO MORE THAN 8 FEET ON CENTER OR AS PAVEMENT EDGE, THE CONTRACTOR SHALL DAILY MAINTAIN THE IN OPERABLE CONDITION FOR THE DURATION OF THE PROJECT.

FORM CONSTRUCTION OPERATIONS AS NECESSARY TO MINIMIZE BY PONDED WATER AND GRASS SEED.

SHALL BE PROVIDED THROUGHOUT THE PROGRESS OF THE CEED IN SUCH A MANNER AS TO PROVIDE SAFE CONDITIONS AIRPORT PERSONNEL AND THE ENGINEER'S REPRESENTATIVES. SHALL BE SUCH THAT MAXIMUM PROTECTION IS AFFORDED TO WORKERS IN THE WORK AREA ARE NOT SUBJECT TO ANY

IS CONTRACT. THE AIRPORT FUELING AREAS. AND AIRCRAFT AIN IN USE BY AIRCRAFT. THE CONTRACTOR SHALL NOT ALLOW SUPPLIERS, OR ANY OTHER UNAUTHORIZED PERSON TO ENTER AREA WHICH WOULD BE HAZARDOUS TO PERSONS OR TO

RED SAFETY PROBLEMS AND/OR HAZARDS:

ATION ON OR ADJACENT TO ANY OPEN RUNWAY OR IN AREAS.

OR EXCAVATION IN ANY APRON, OPEN TAXIWAY, OPEN AREA.

CONSTRUCTION MATERIALS, TEMPORARY STRUCTURES, /ICINITY OF ANY OPEN RUNWAY, TAXIWAY, TAXILANE, OR IN ACH, OR DEPARTURE AREA.

ETHER OPERATING OR IDLE, ON ANY OPEN RUNWAY, RELATED SAFETY, APPROACH, OR DEPARTURE AREA.

ATION, STOCKPILES, OR OTHER MATERIALS WHICH TRONIC SIGNALS FROM RADIOS OR ELECTRONIC

(EITHER PERMANENT OR TEMPORARY) WHICH COULD IF CROSSED AT NORMAL OPERATING SPEEDS. THE NORMAL IS 1-1/2 INCHES.

EATHER SERVICE, RUNWAY LIGHTING, OR OTHER POWER OR BE DAMAGED DURING CONSTRUCTION.

MARKED OR FLAGGED, OR ACTIVITIES ANYWHERE ON OR IN WHICH COULD BE DISTRACTING, CONFUSING, OR AIRCRAFT OPERATIONS.

VISIBILITY ITEMS SUCH AS TALL CRANES, DRILLS, AND VICINITY OF ACTIVE RUNWAYS, OR IN ANY APPROACH OR

DUCT ACTIVITIES SO AS NOT TO VIOLATE ANY SAFETY STANDARDS TRACTOR SHALL INSPECT ALL CONSTRUCTION AND STORAGE ARY AND PROMPTLY TAKE ALL STEPS NECESSARY TO OR POTENTIALLY UNSAFE CONDITIONS OR ACTIVITIES

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1. TOPOGRAPHIC SURVEY COMPLETED BY STANTEC CONSULTING SERVICES 2021, BASED ON THE SECONDARY AIRPORT CONTROL STATION, DESIGN PUBLISHED COORDINATES ARE N41'30'37.86554" W072'49'51.02089" ELEVATION OF 99.0 FEET NAVD 88.


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2. ALL SURVEY LAYOUT AND CONTROL SHALL BE COMPLETED BY A PROF REGISTERED IN THE STATE OF CONNECTICUT.

## UNDERGROUND UTILITY NOTES

- 1. THE LOCATIONS OF THE UNDERGROUND UTILITIES SHOWN ON THE F BE ONLY ESTIMATED LOCATIONS. ALL UTILITY LOCATIONS SHALL BE CONTRACTOR PRIOR TO COMMENCING CONSTRUCTION.
- 2. PROTECTION OF EXISTING AIRPORT UNDERGROUND CABLES IS THE F CONTRACTOR. THE LOCATION OF THESE UTILITIES MUST BE VERIFIED REPAIR OF CABLES DAMAGED DUE TO CONTRACTOR'S OPERATIONS M IMMEDIATELY AND CONTINUED UNTIL COMPLETED. ALL SUCH REPAIRS WITH THE SPECIFICATIONS AND SHALL BE AT THE CONTRACTOR'S EX ARE DAMAGED, REPAIRS SHALL BE DONE IN ACCORDANCE WITH FAA PRESENCE OF AN FAA REPRESENTATIVE. THE FAA MAY ELECT TO HA BY OTHERS IN WHICH CASE THE CONTRACTOR SHALL BE RESPONSI INCURRED COST OF REPAIRS.
- 3. AT LEAST TWO (3) WORKING DAYS PRIOR TO COMMENCING CONSTRU AREA WHICH MAY INVOLVE UNDERGROUND UTILITY FACILITIES, THE C THE ENGINEER AND THE OWNER OF EACH UNDERGROUND UTILITY F.
- 4. AT LEAST TWO (2) FULL WORKING DAYS PRIOR TO COMMENCEMENT CONTRACTOR SHALL CONTACT "CALL BEFORE YOU DIG" AT 1-800-9 ASSISTANCE IN LOCATING UNDERGROUND UTILITIES.



SAFETY BARRICADE NOTES:

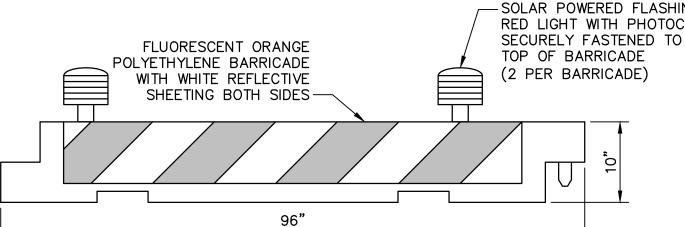- 1. THERE IS NO SEPARATE PAY ITEM FOR LIGHTED SAFETY BARRICADES AND THIS WORK IS CONSIDERED INCIDENTAL TO THE PROJECT.
- 2. THE LIGHTED SAFETY BARRICADES SHALL BE USED WHEN A WORK AREA IS DIRECTLY ADJACENT TO AN ACTIVE RUNWAY, TAXIWAY OR TAXILANE TO KEEP AIRCRAFT AND VEHICLES FROM TRAVELING INTO A WORK AREA.
- 3. BARRICADES SHALL BE INTERCONNECTED ON AIRFIELD PAVEMENTS OR AS IDENTIFIED ON PLANS.
- 4. THE CONTRACTOR SHALL BE RESPONSIBLE FOR RELOCATING AND/OR PROVIDING ADDITIONAL BARRICADES AROUND THE SITE AS NECESSARY TO ACCOMMODATE THE PROPOSED WORK.
- 5. THE CONTRACTOR SHALL ENSURE THE CONTINUOUS OPERATION OF ALL LIGHTS FOR THE DURATION OF THE PROJECT. LIGHTS AND/OR BATTERIES SHALL BE REPLACED AS NEEDED.
- 6. THE BARRICADES SHALL BE FILLED WITH WATER OR OTHERWISE SECURED TO PREVENT MOVEMENT.

TYPICAL LOW-PROFILE BARRICADE DETAIL NOT TO SCALE







3 Columbia Circle, Suite 6 Albany, New York 12203 www.stantec.com

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Client/Project MERIDEN N

RUNWAY

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File Name: 179450289


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LIGHTED RUNWAY CLOSURE 'X' NOTES:

- 1. THERE IS NO SEPARATE PAY ITEM FOR LIGHTED RUNWAY CLOSURE 'X'S AND THIS WORK IS CONSIDERED INCIDENTAL TO THE PROJECT.
- 2. THE CONTRACTOR SHALL PROVIDE TWO (2) LIGHTED X'S FOR THE DURATION OF THE RUNWAY CLOSEURE. THE LIGHTED X'S SHALL MEET THE REQUIREMENTS SPECIFIED IN FAA AC 150/5345-55A AND SHALL BE IN GOOD WORKING ORDER. LIGHT BULBS SHALL BE REPLACED WITHIN 24HR OF BEING NOTIFIED FROM THE AIRPORT OR RESIDENT ENGINEER.
- 3. THE LIGHTED X'S SHALL HAVE THE FUEL CAPACITY TO RUN UNINTERRUPTED THROUGH OUT THE NIGHT. FROM END OF WORK DAY UNTIL THE BEGINNING OF THE NEXT DAYS WORK SHIFT. THE CONTRACTOR SHALL MAKE PROVISIONS TO REFUEL DURING THE WEEKEND AND/OR EXTENDED PERIODS OF DOWN-TIME.
- 4. THE CONTRACTOR IS RESPONSIBLE FOR THE LIGHTED X'S TO BE FULLY FUNCTIONAL THROUGHOUT WEEKENDS AND HOLIDAYS.


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EXISTING FAA REL (TYP.), DO NOT DISTURB	XX	X	X	X	X	- <u>x</u>
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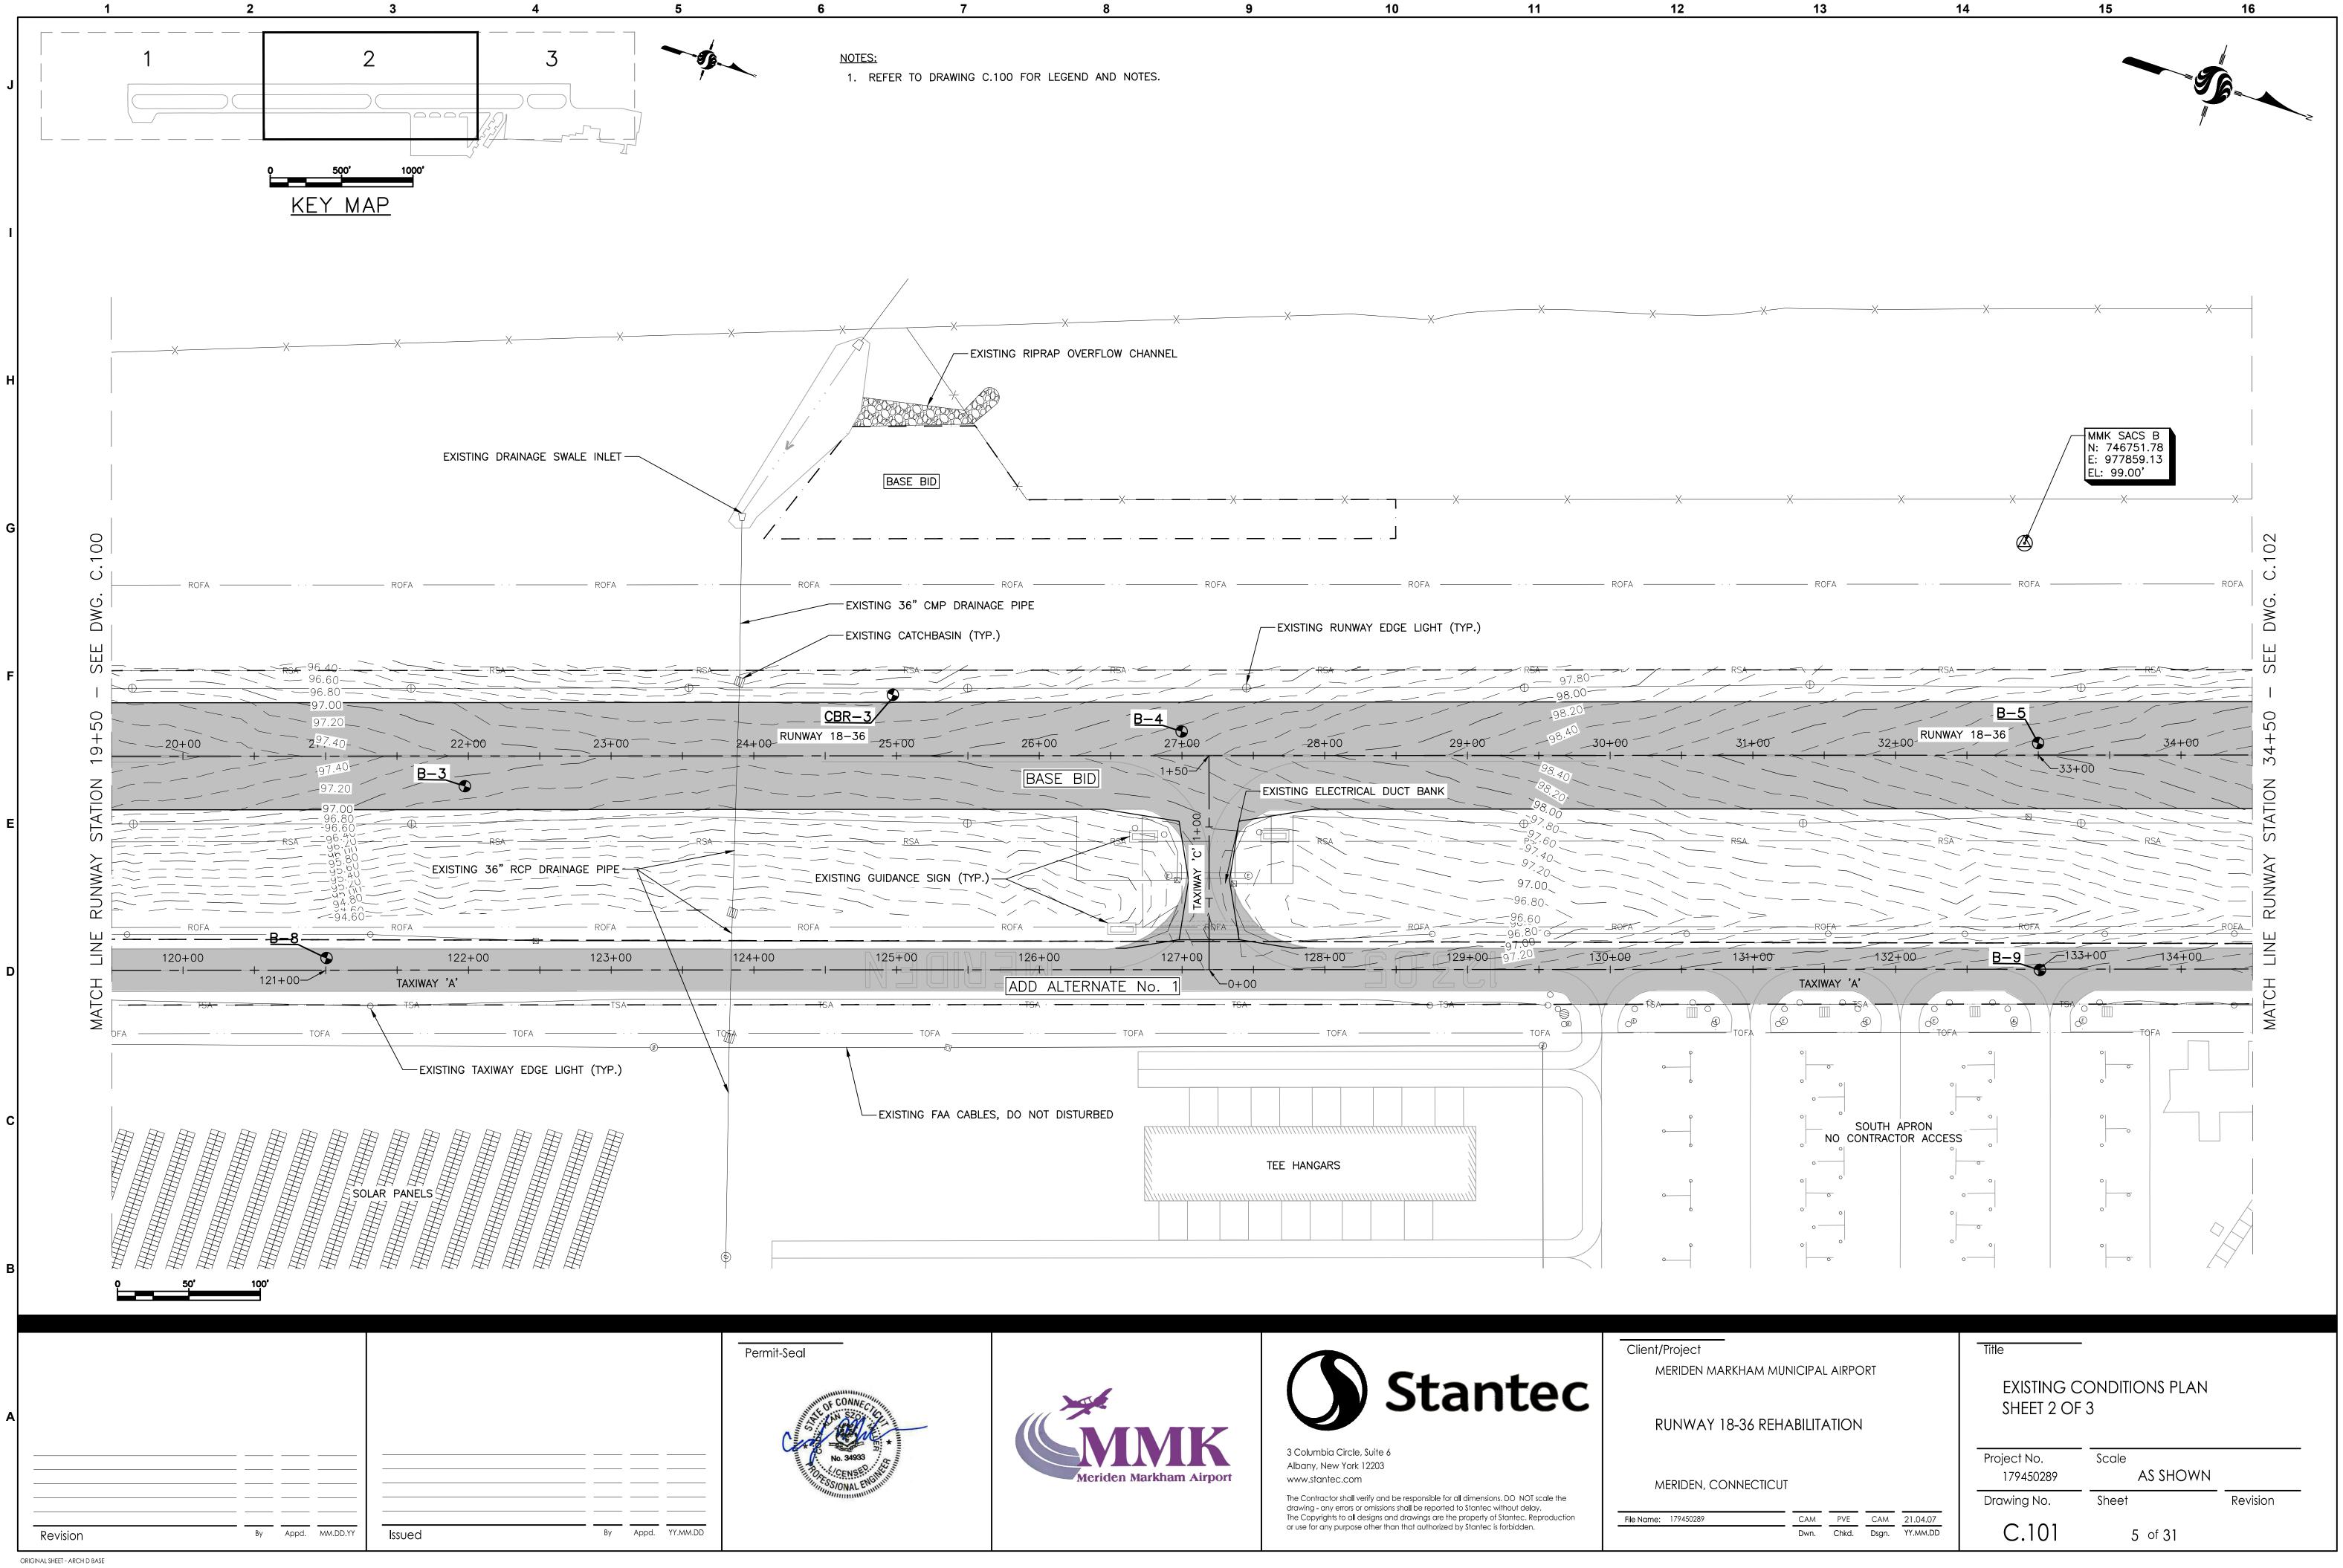
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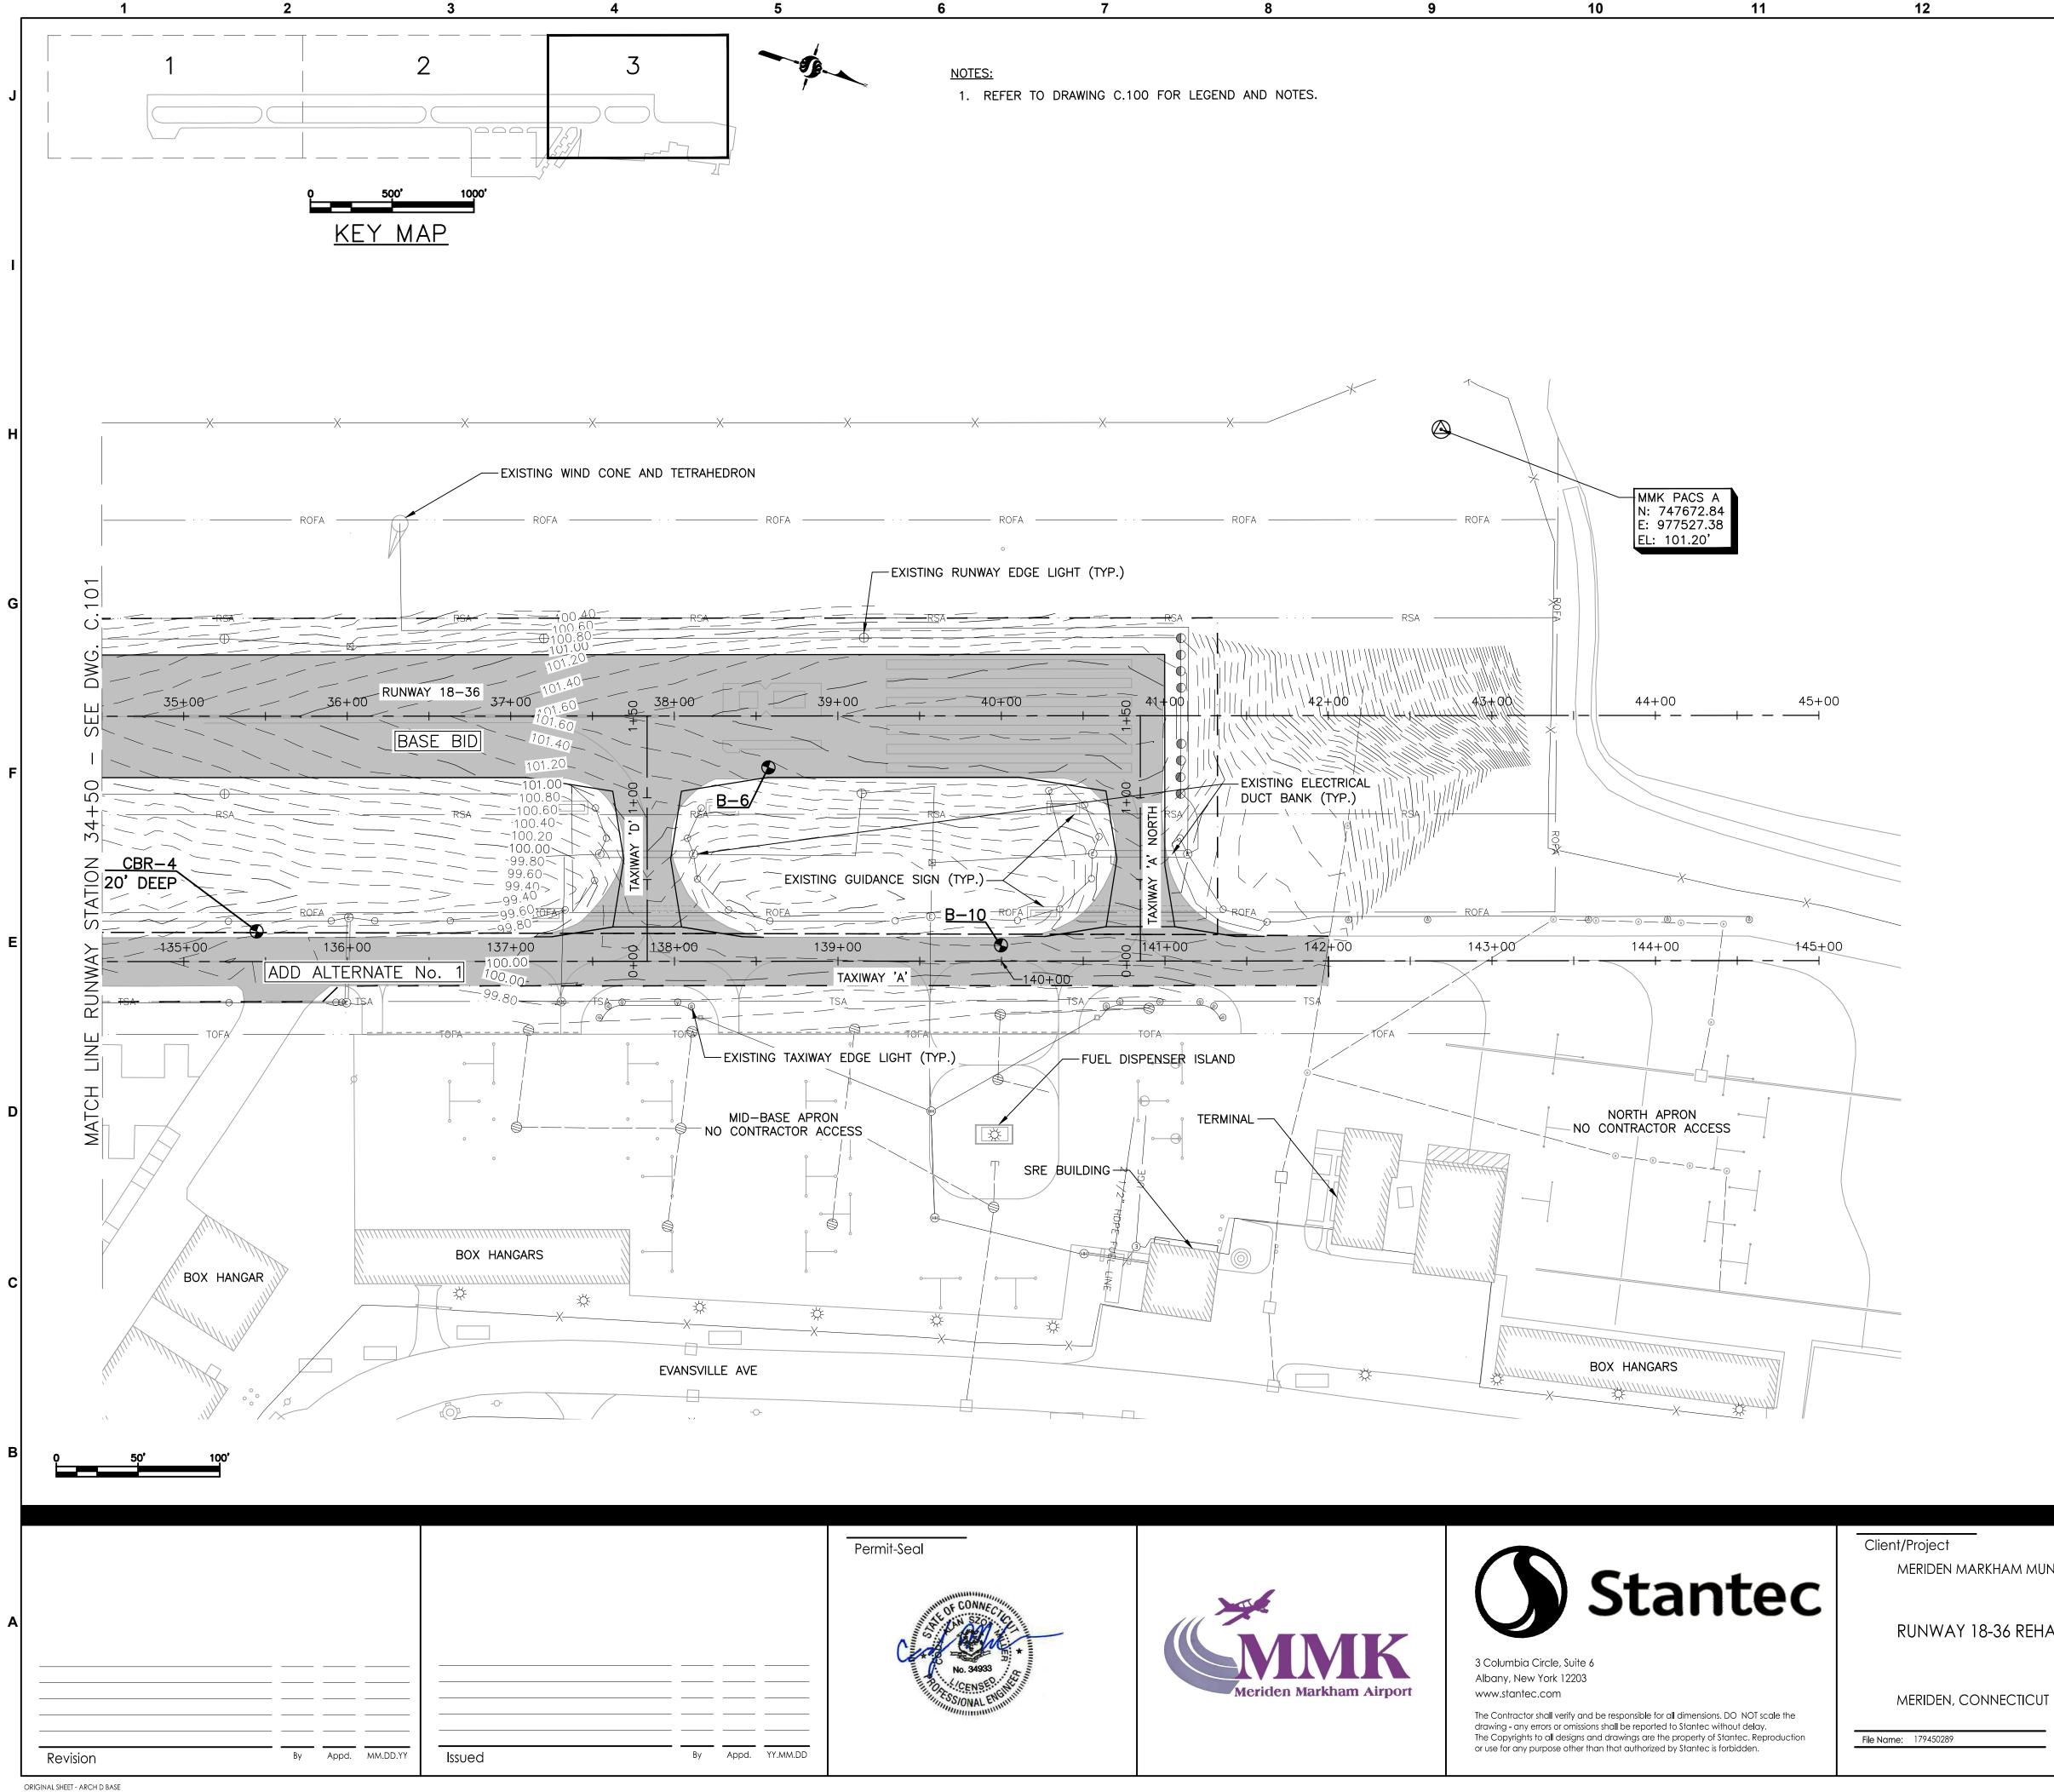


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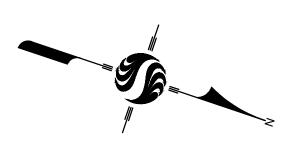


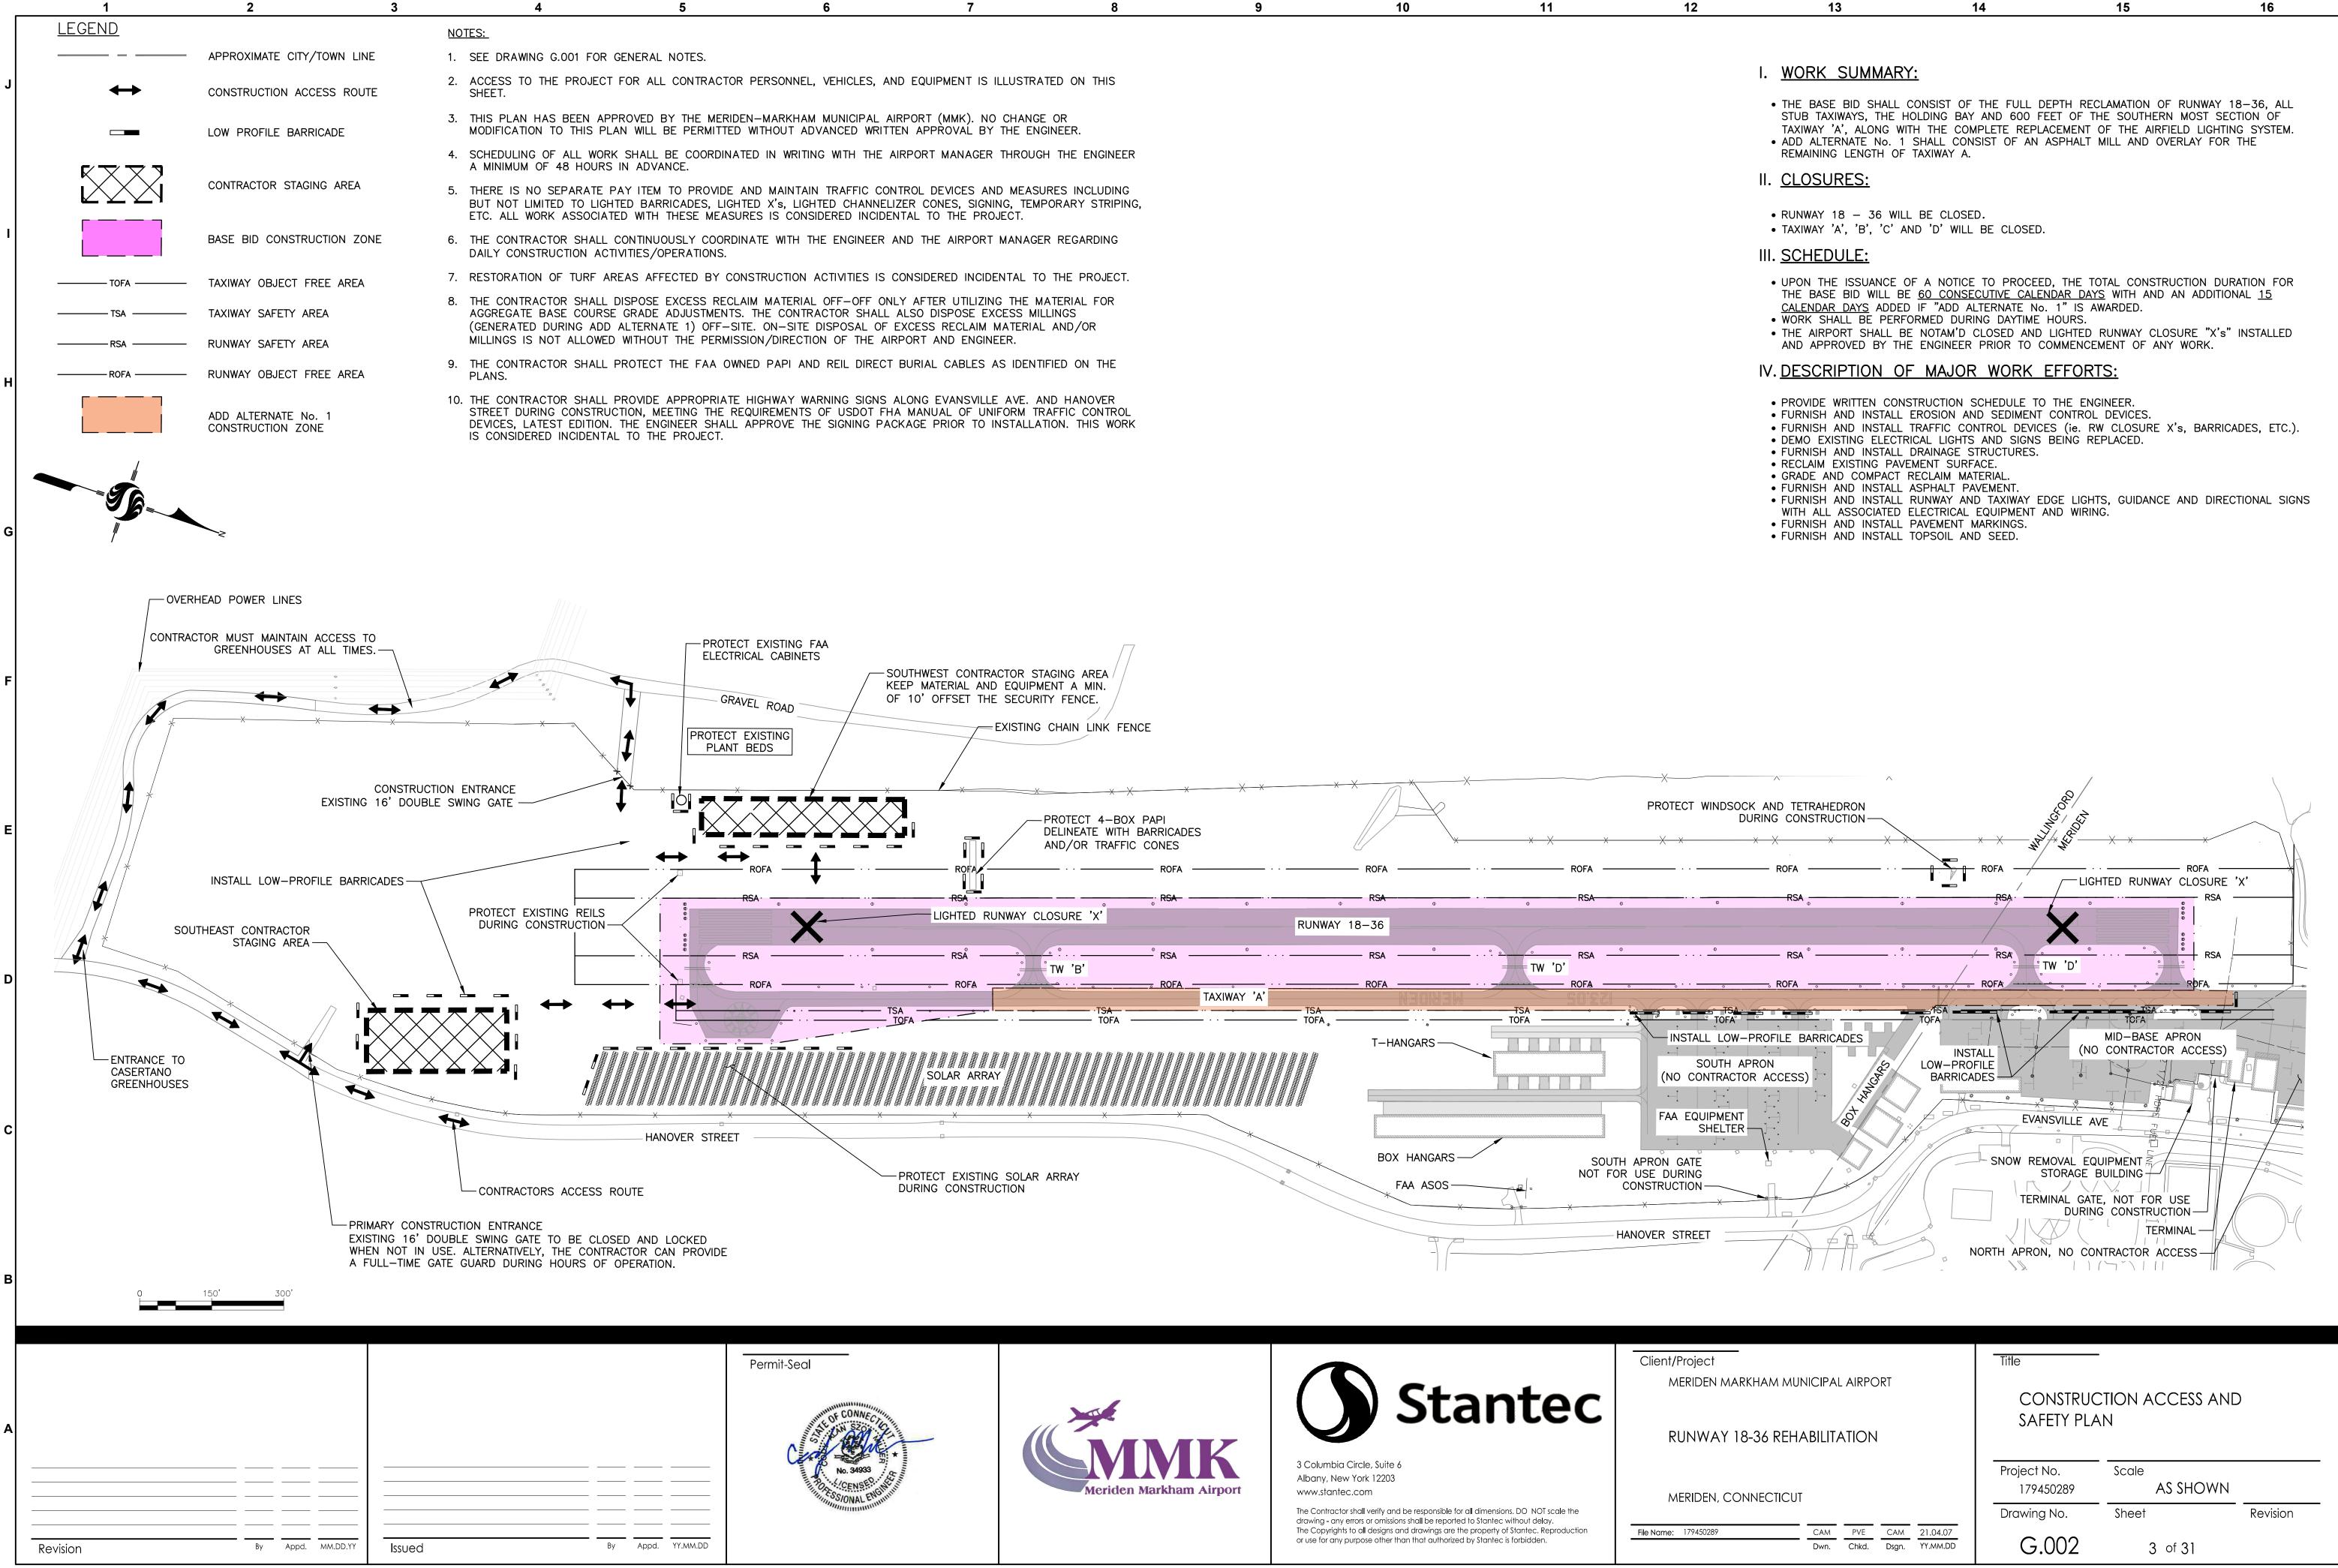


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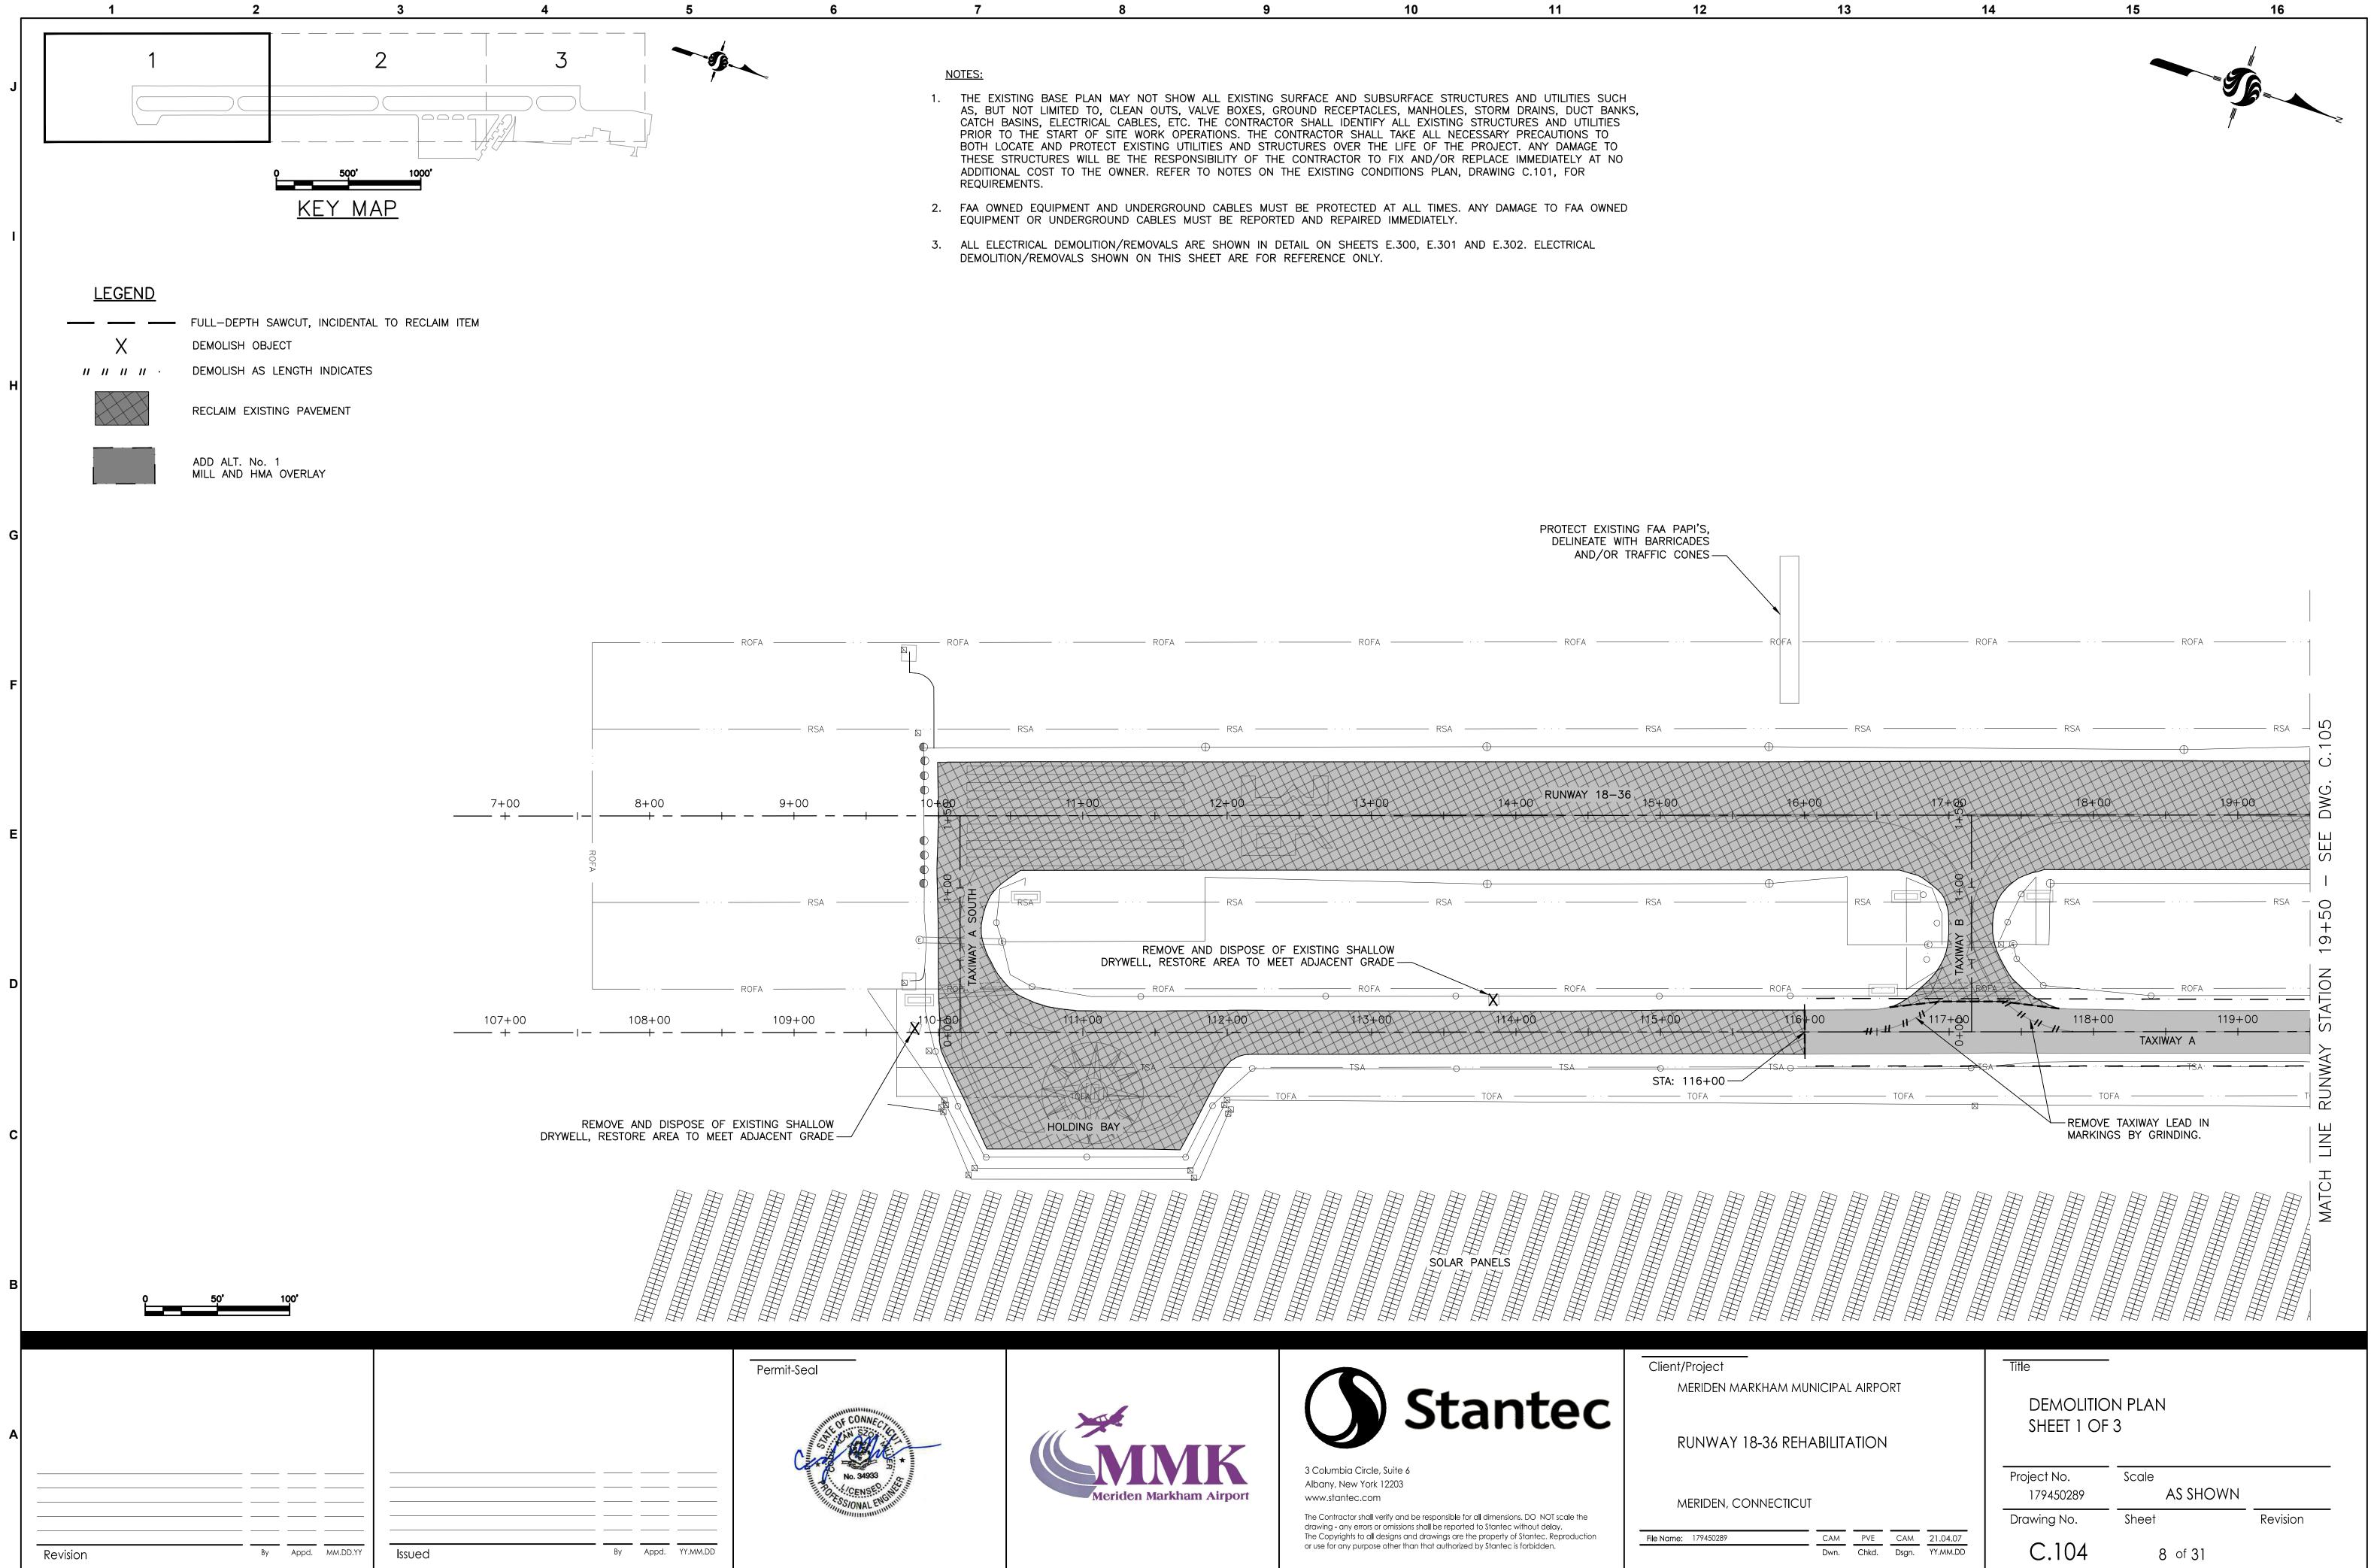
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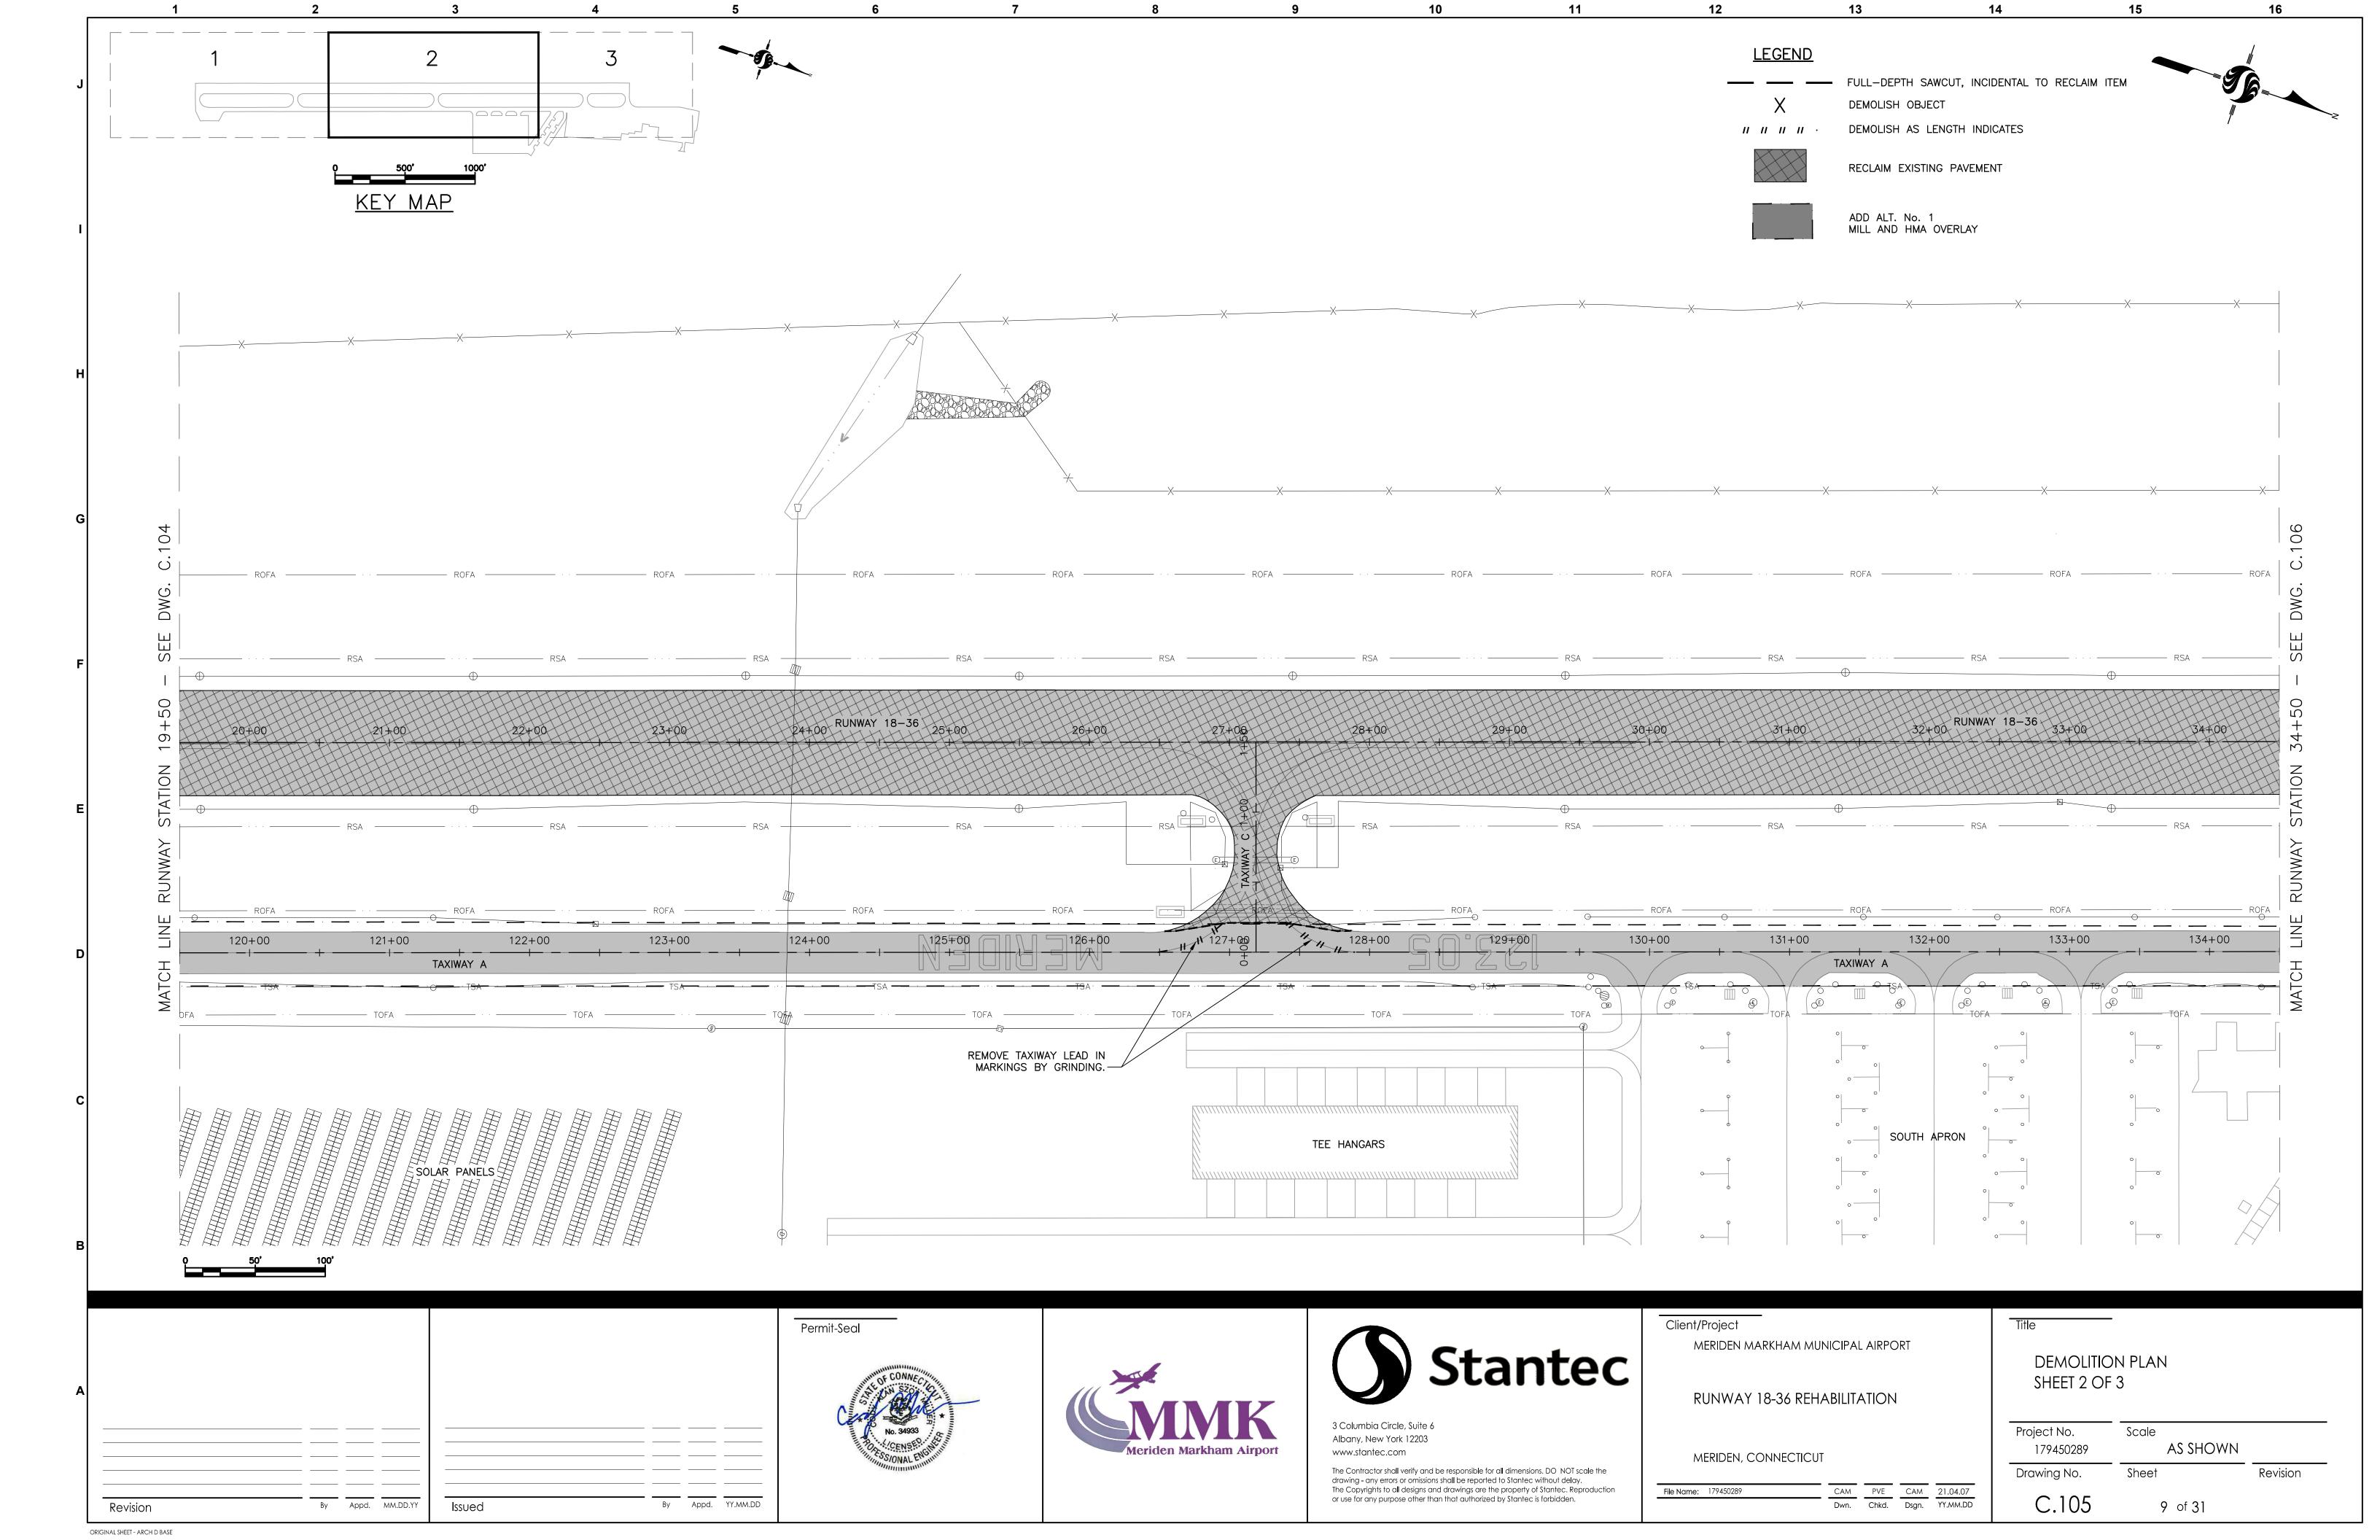



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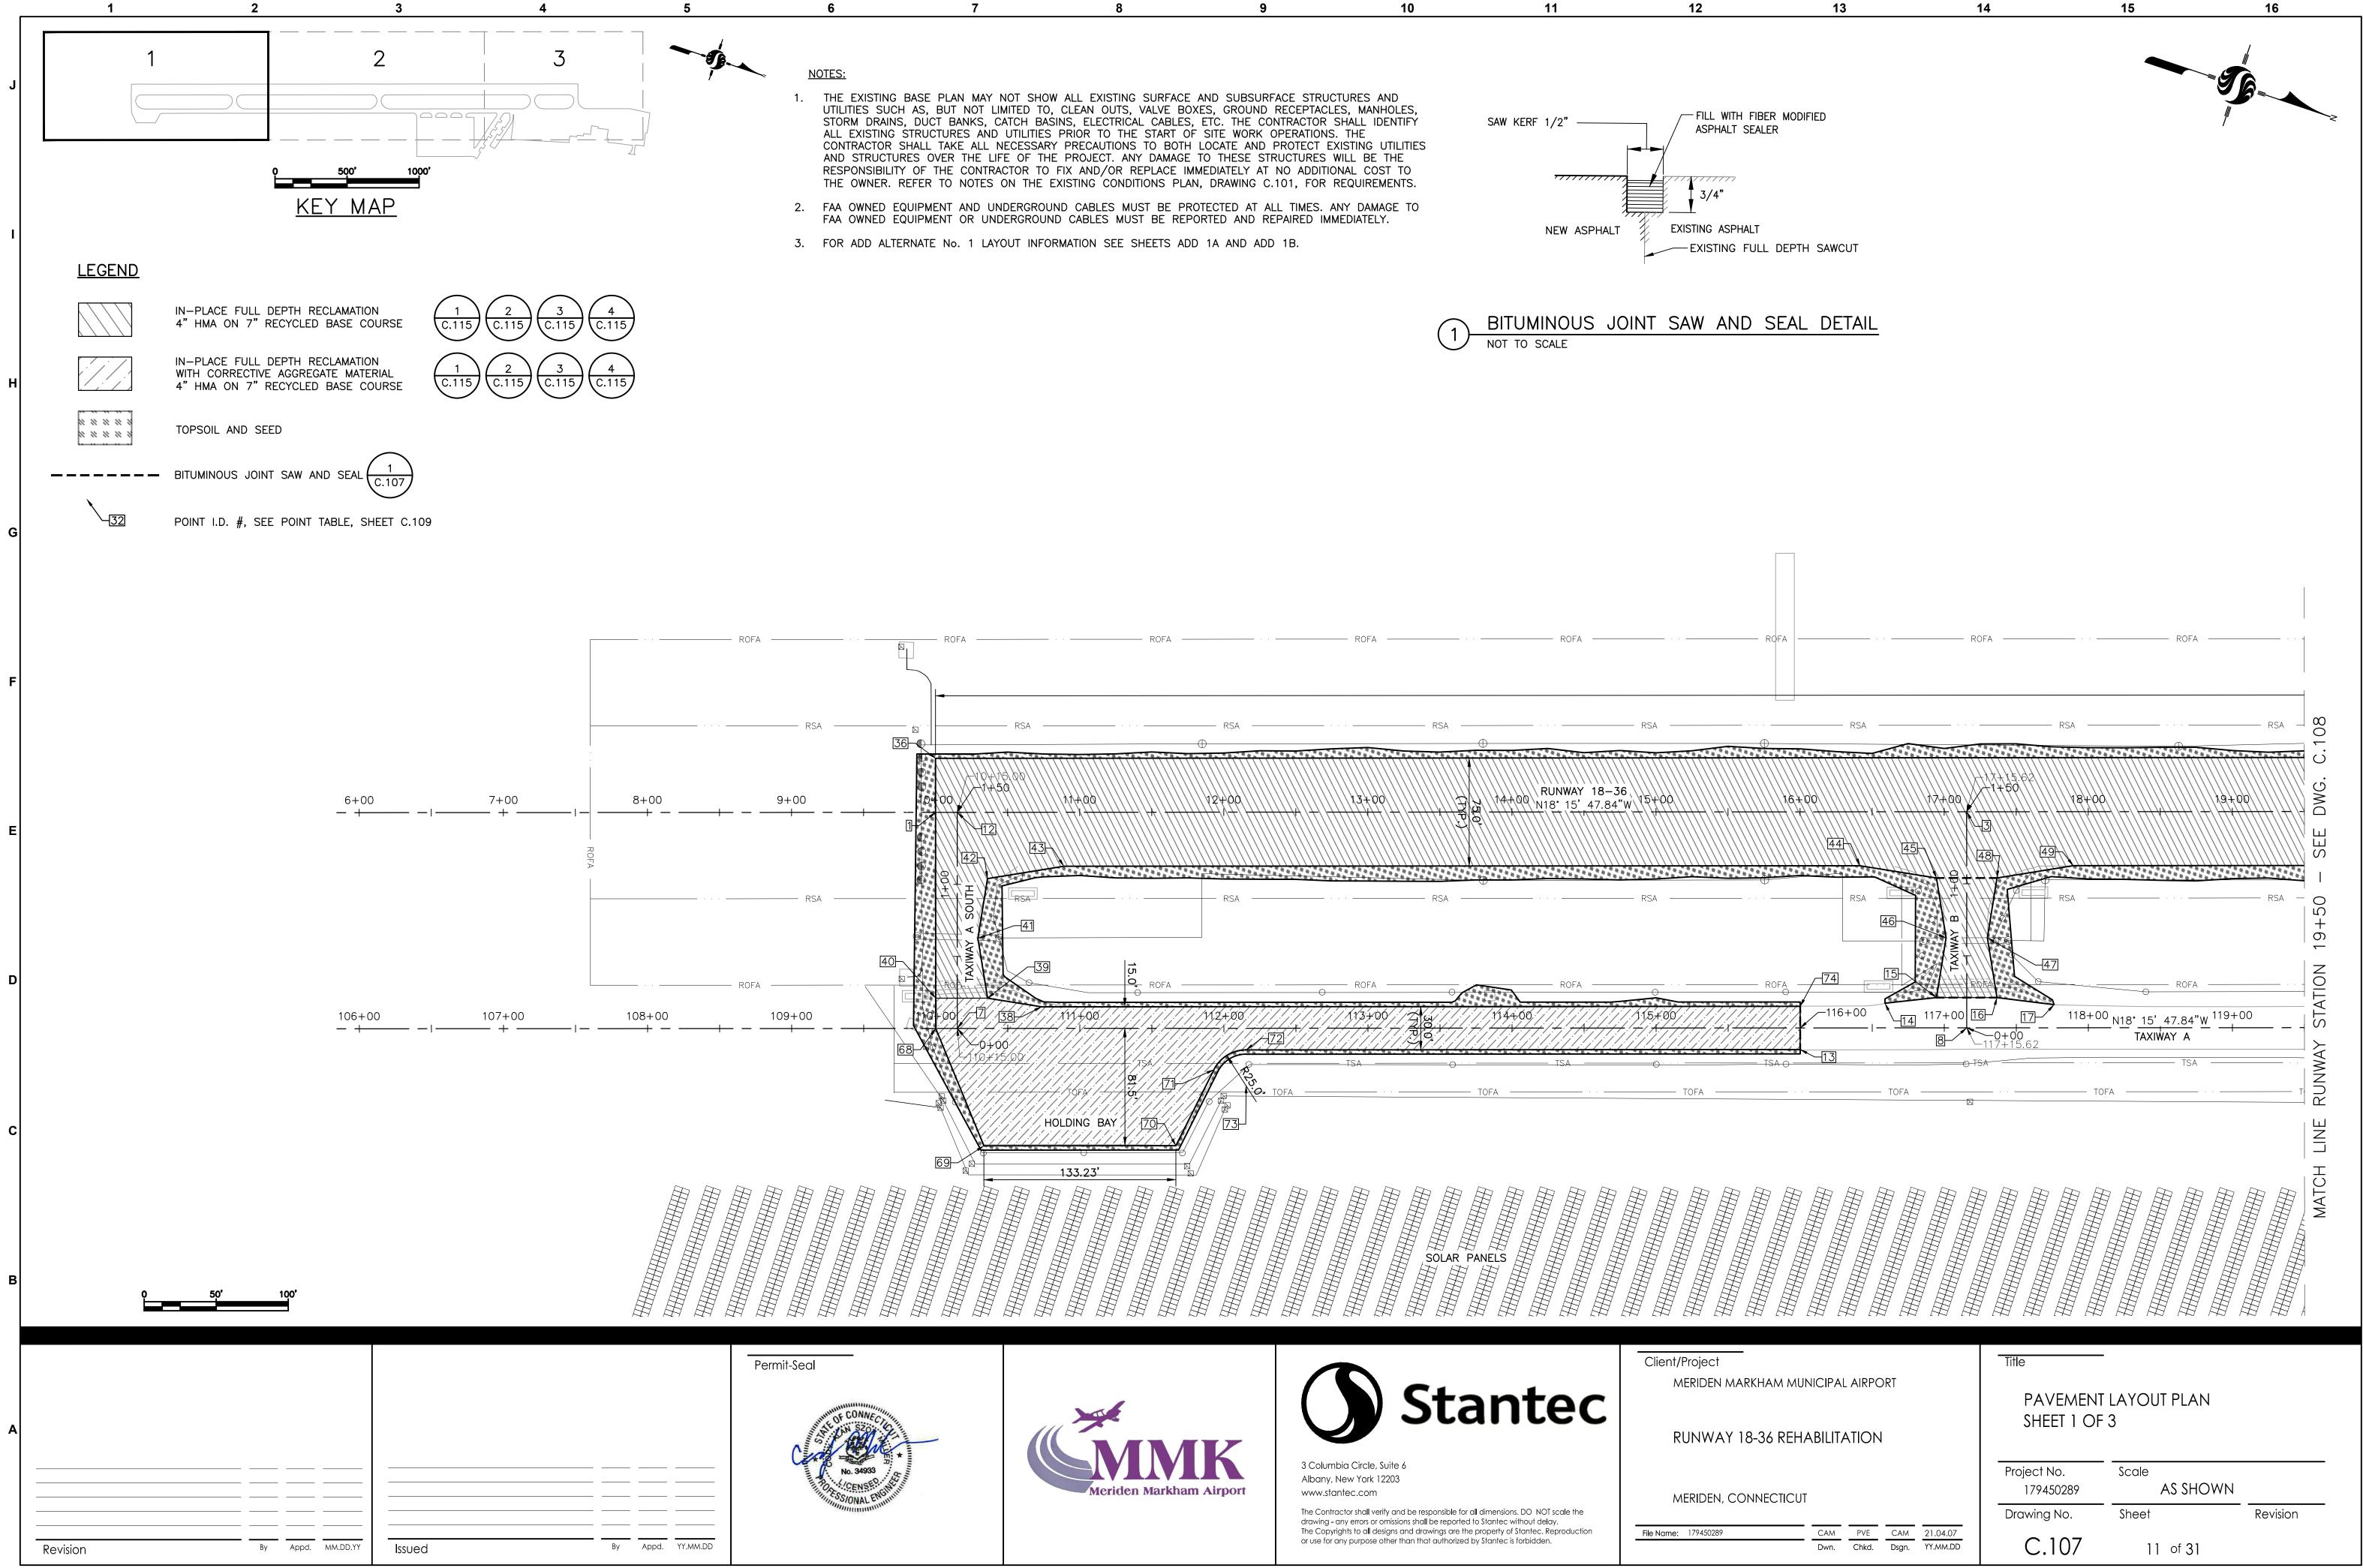


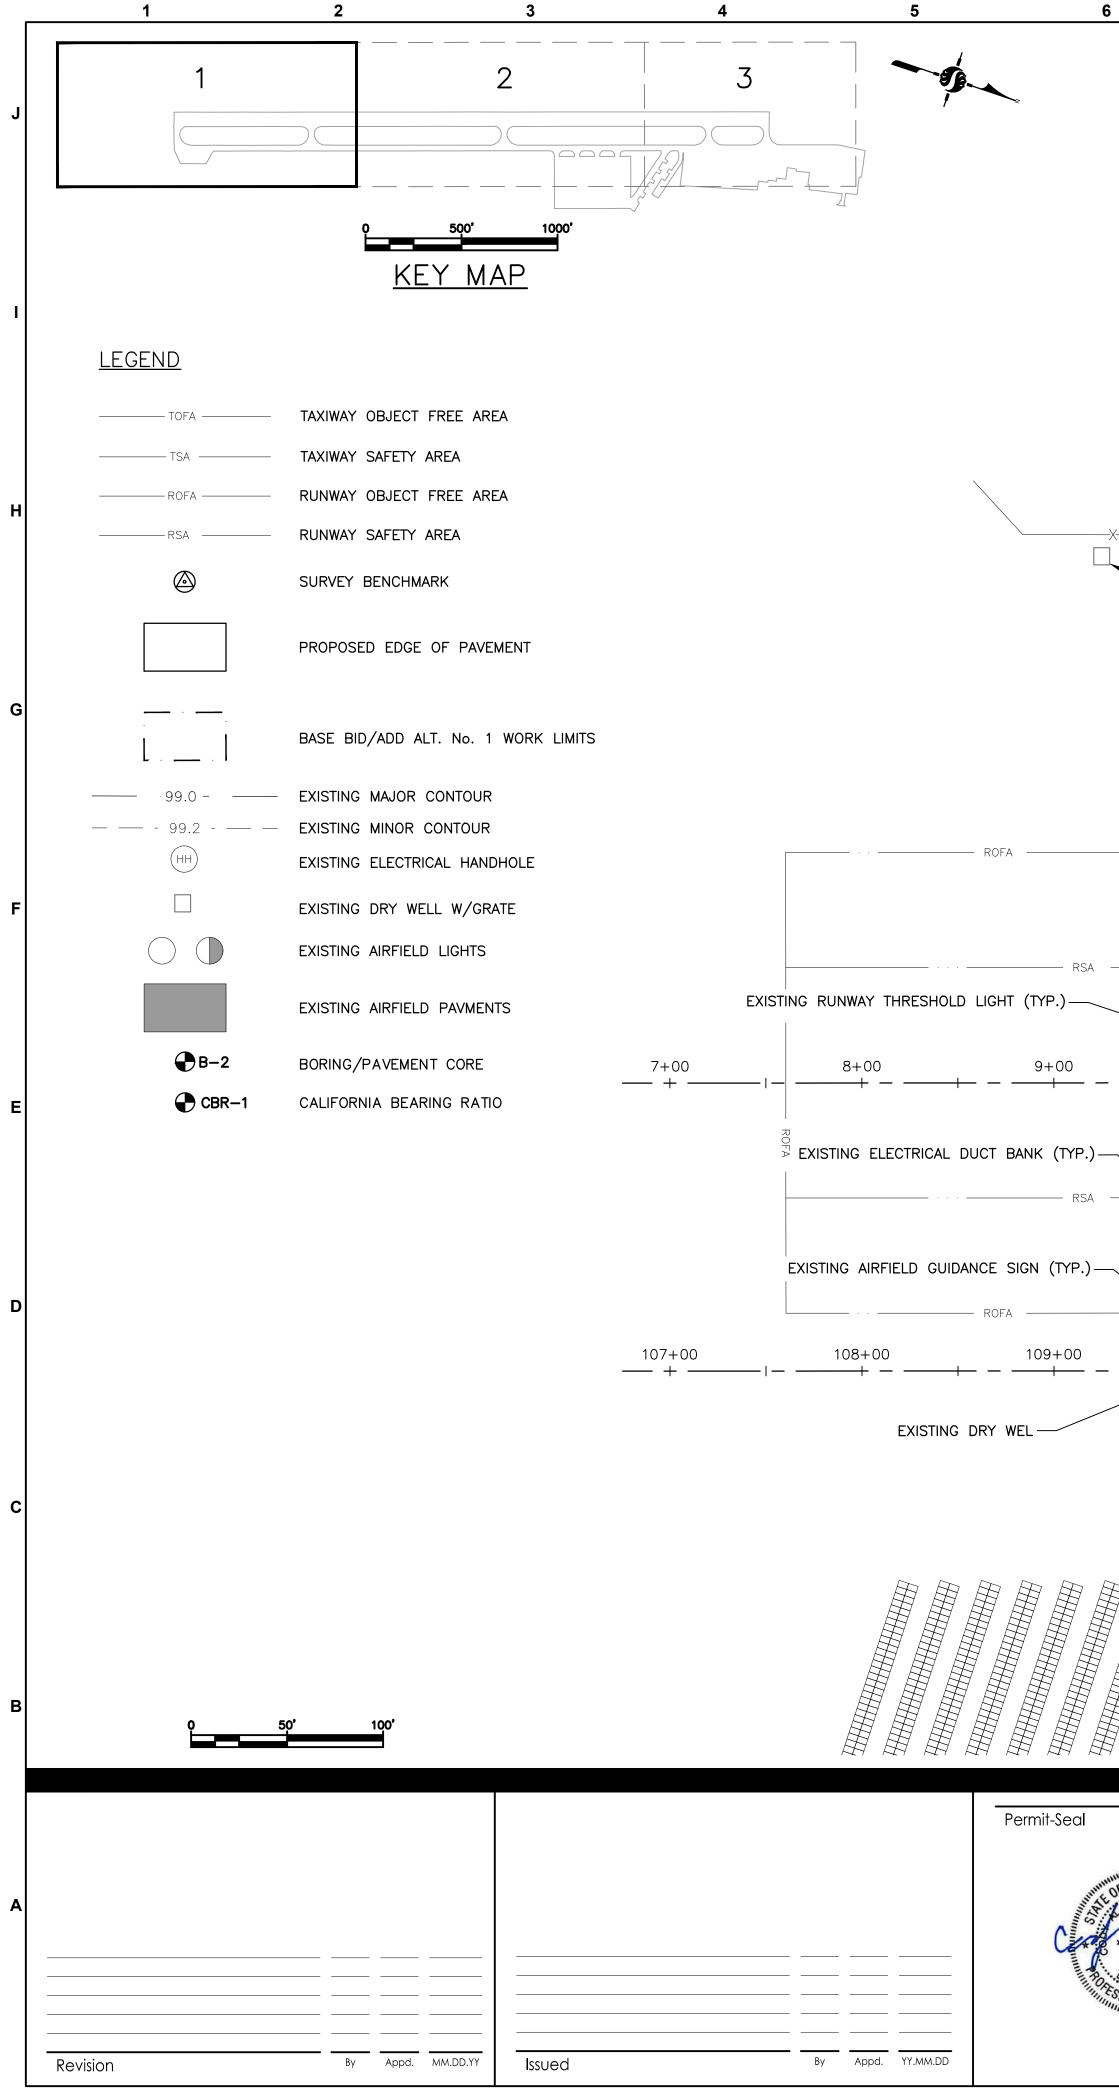


	13	14	15	16
<u>EGEND</u>				
	FULL-DEPTH SAWCUT DEMOLISH OBJECT	, INCIDENTAL TO RECLAIM	ITEM	
∧ 11 11 11 ·	DEMOLISH AS LENGTH	H INDICATES		
	RECLAIM EXISTING PA	VEMENT		

ADD ALT. No. 1 MILL AND HMA OVERLAY

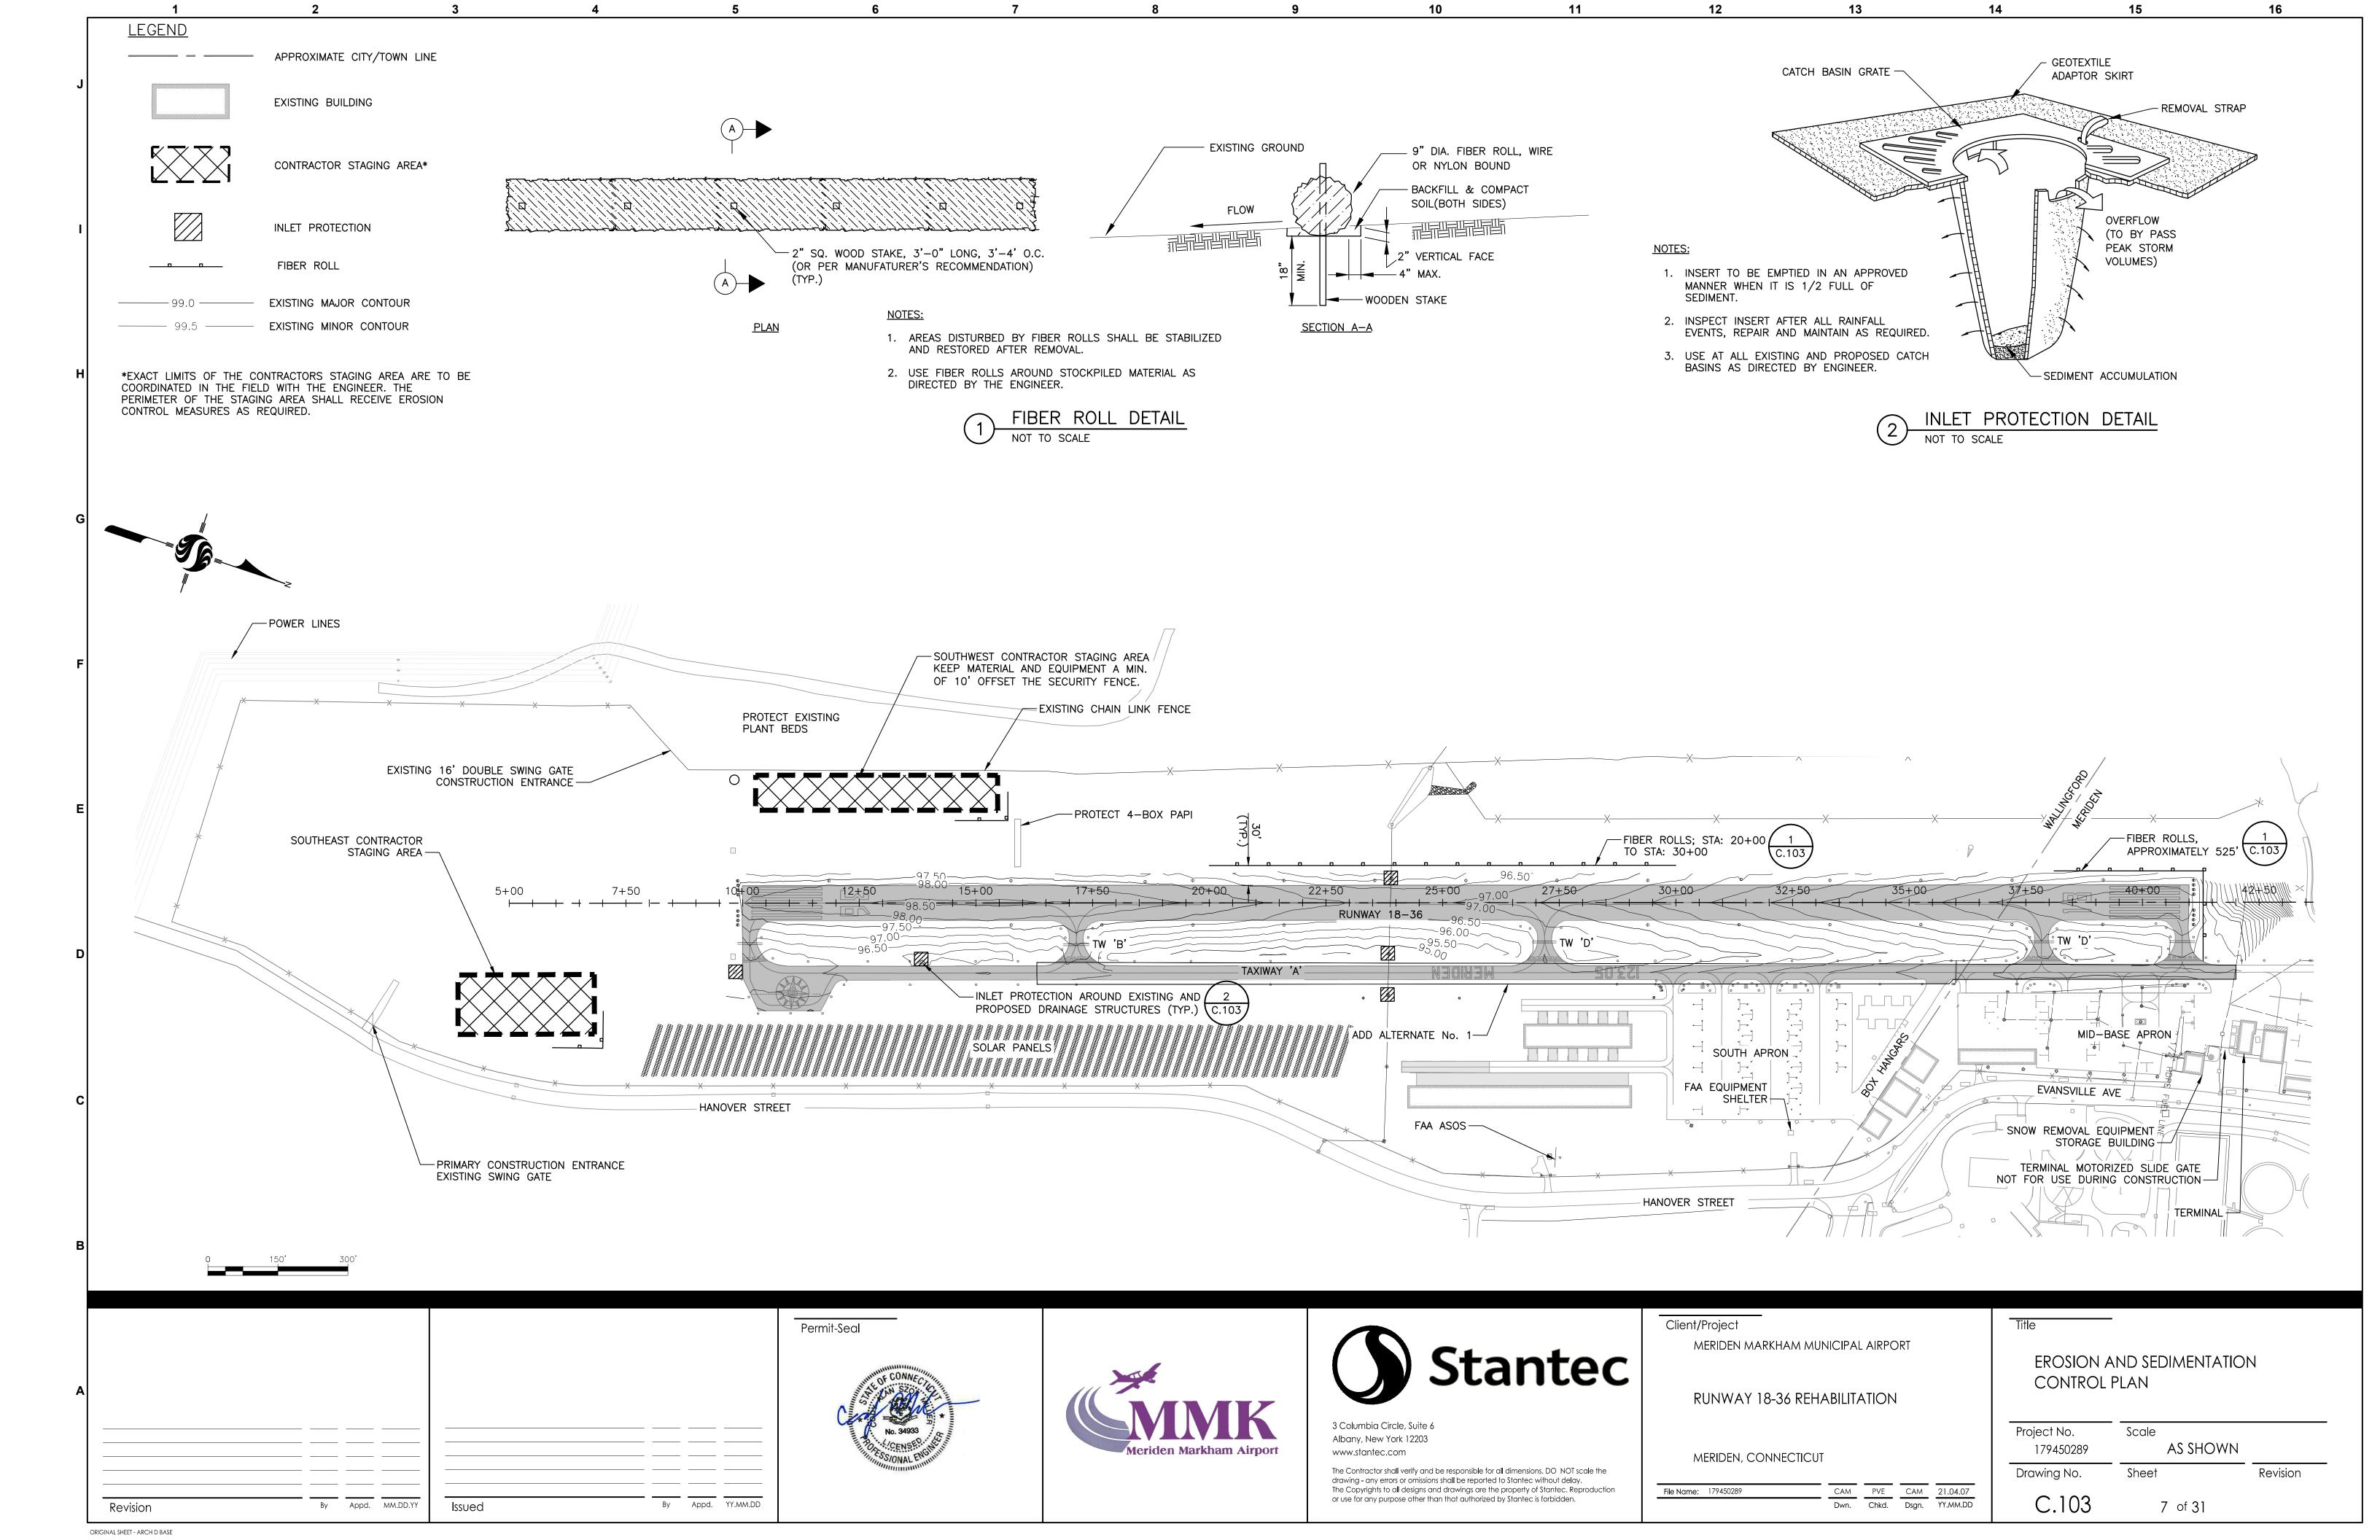
	Title DEMOLITION PLAN		
(18-36 REHABILITATION	Sheet 3 Of	3	
CONNECTICUT	Project No. 179450289	Scale AS SHOWN	
	Drawing No.	Sheet	Revision
CAM PVE CAM 21.04.07 Dwn. Chkd. Dsgn. YY.MM.DD	C.105	10 of 31	

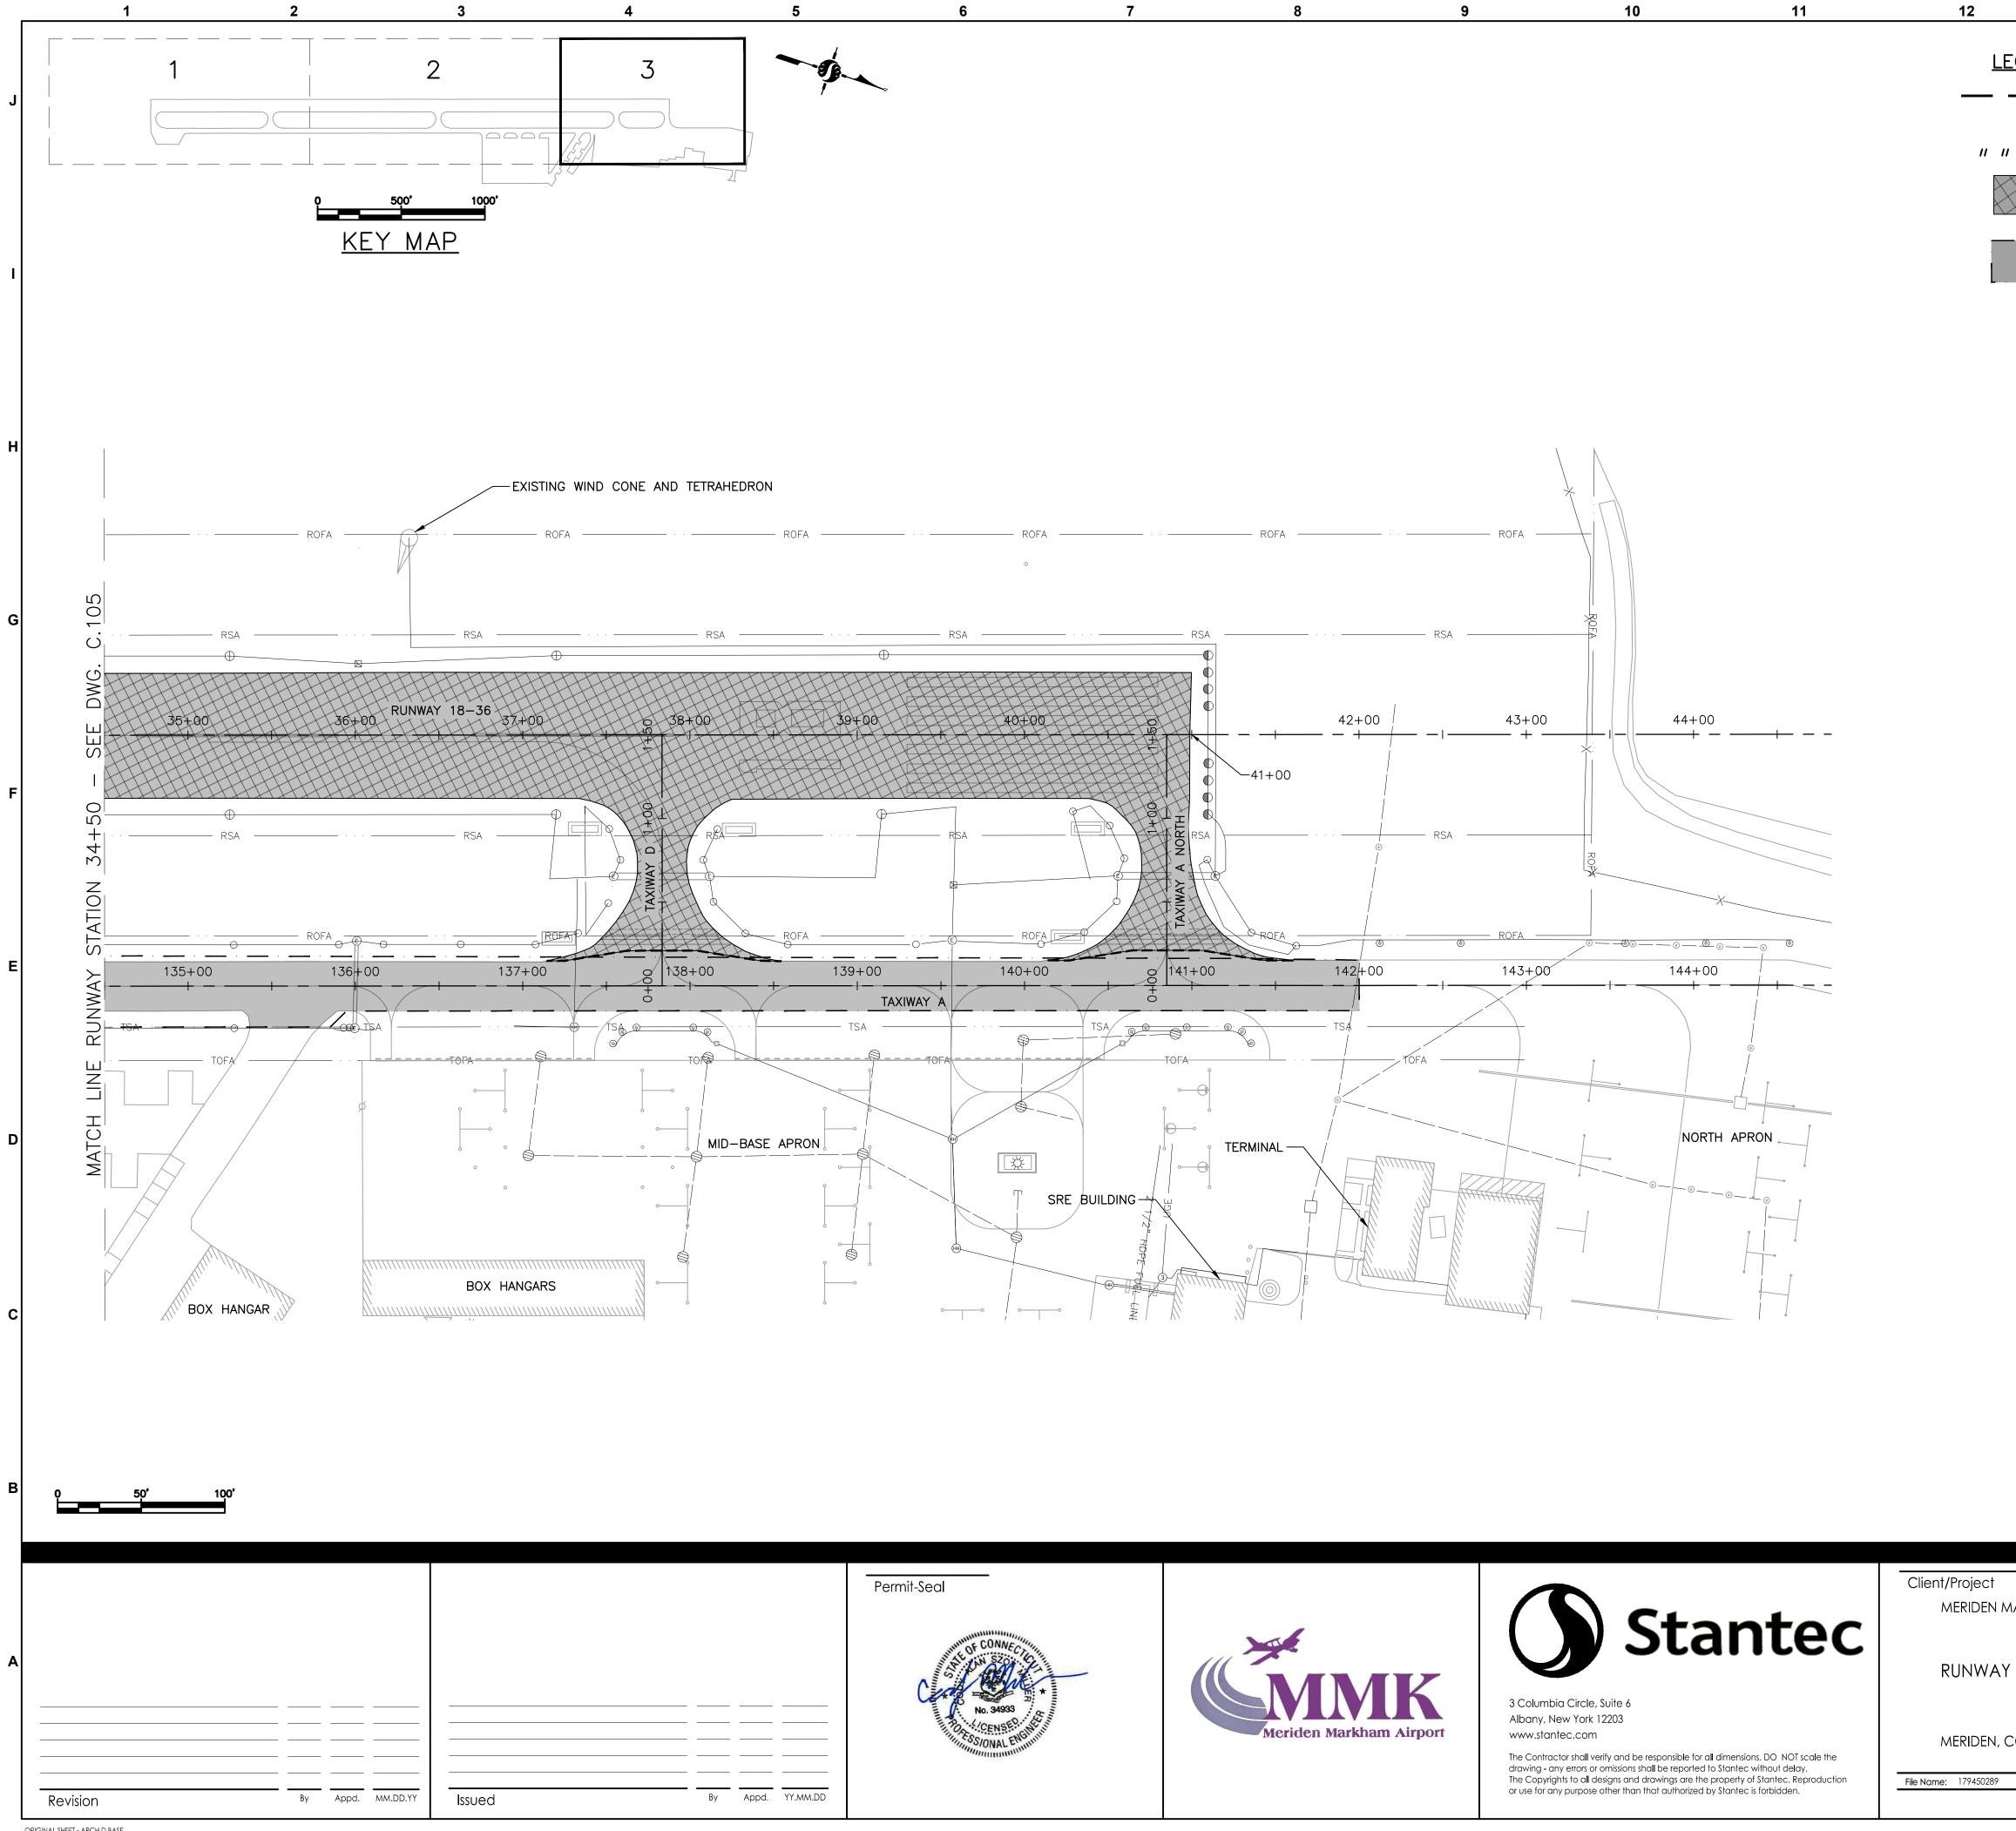

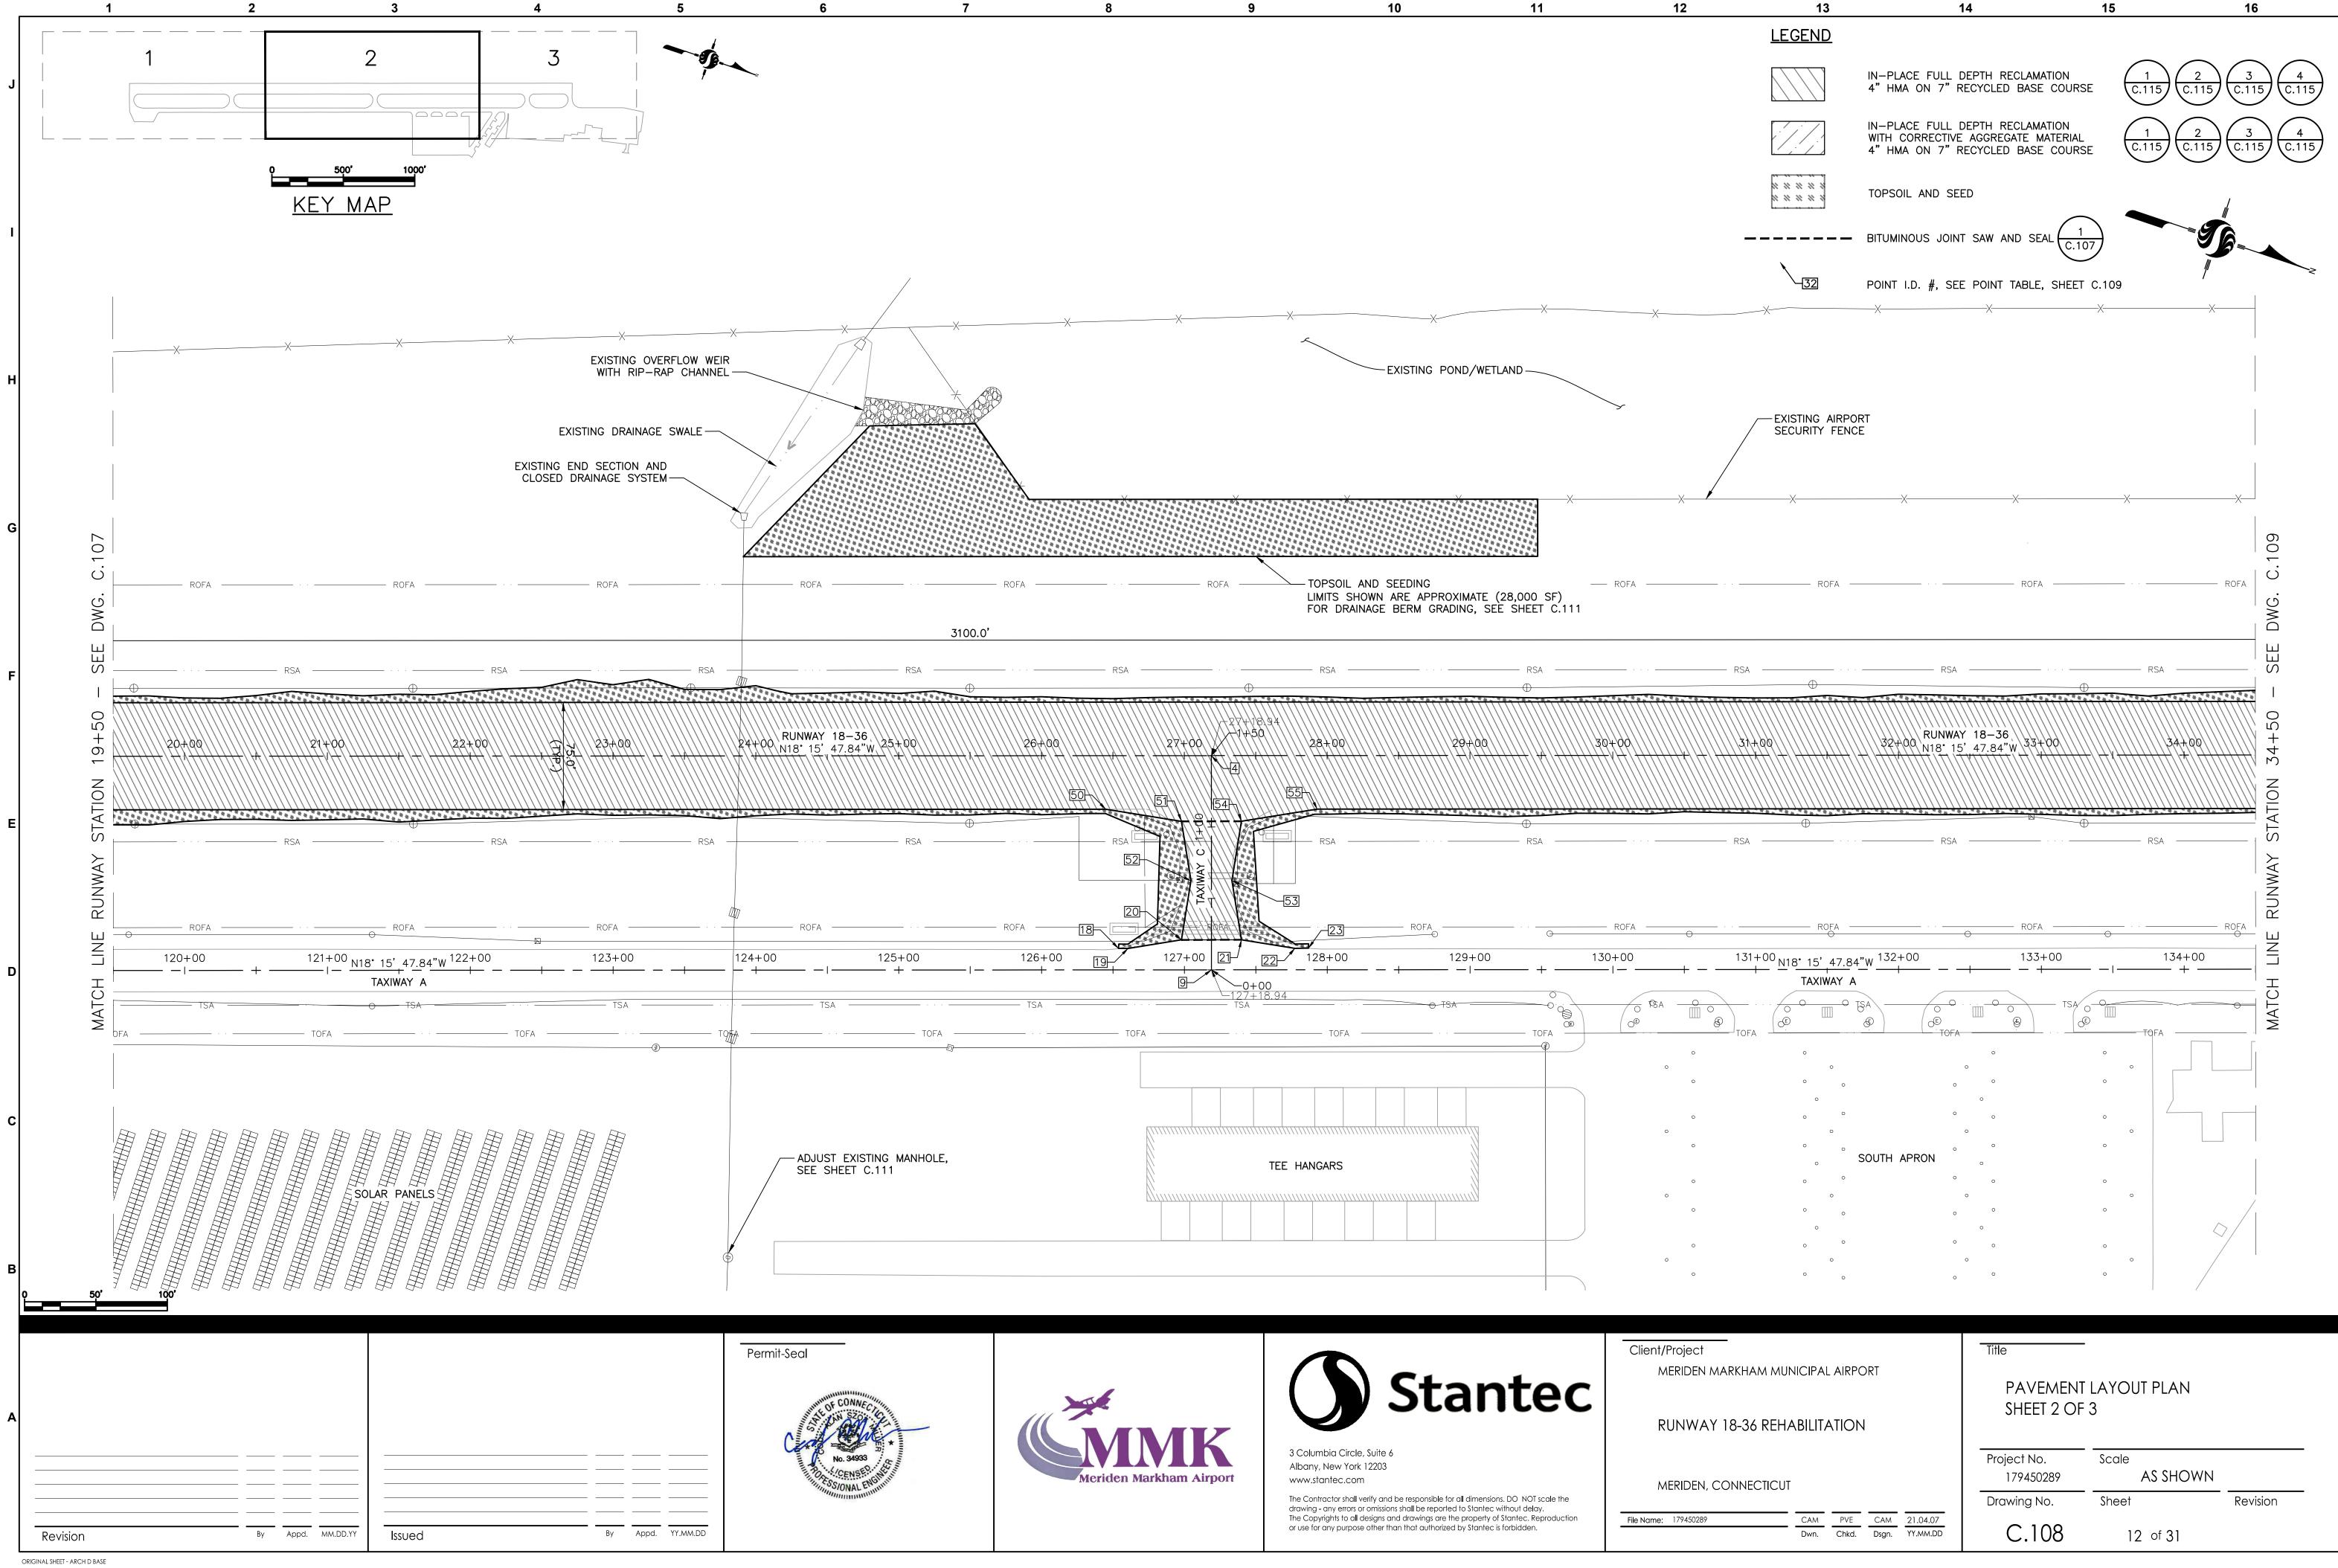





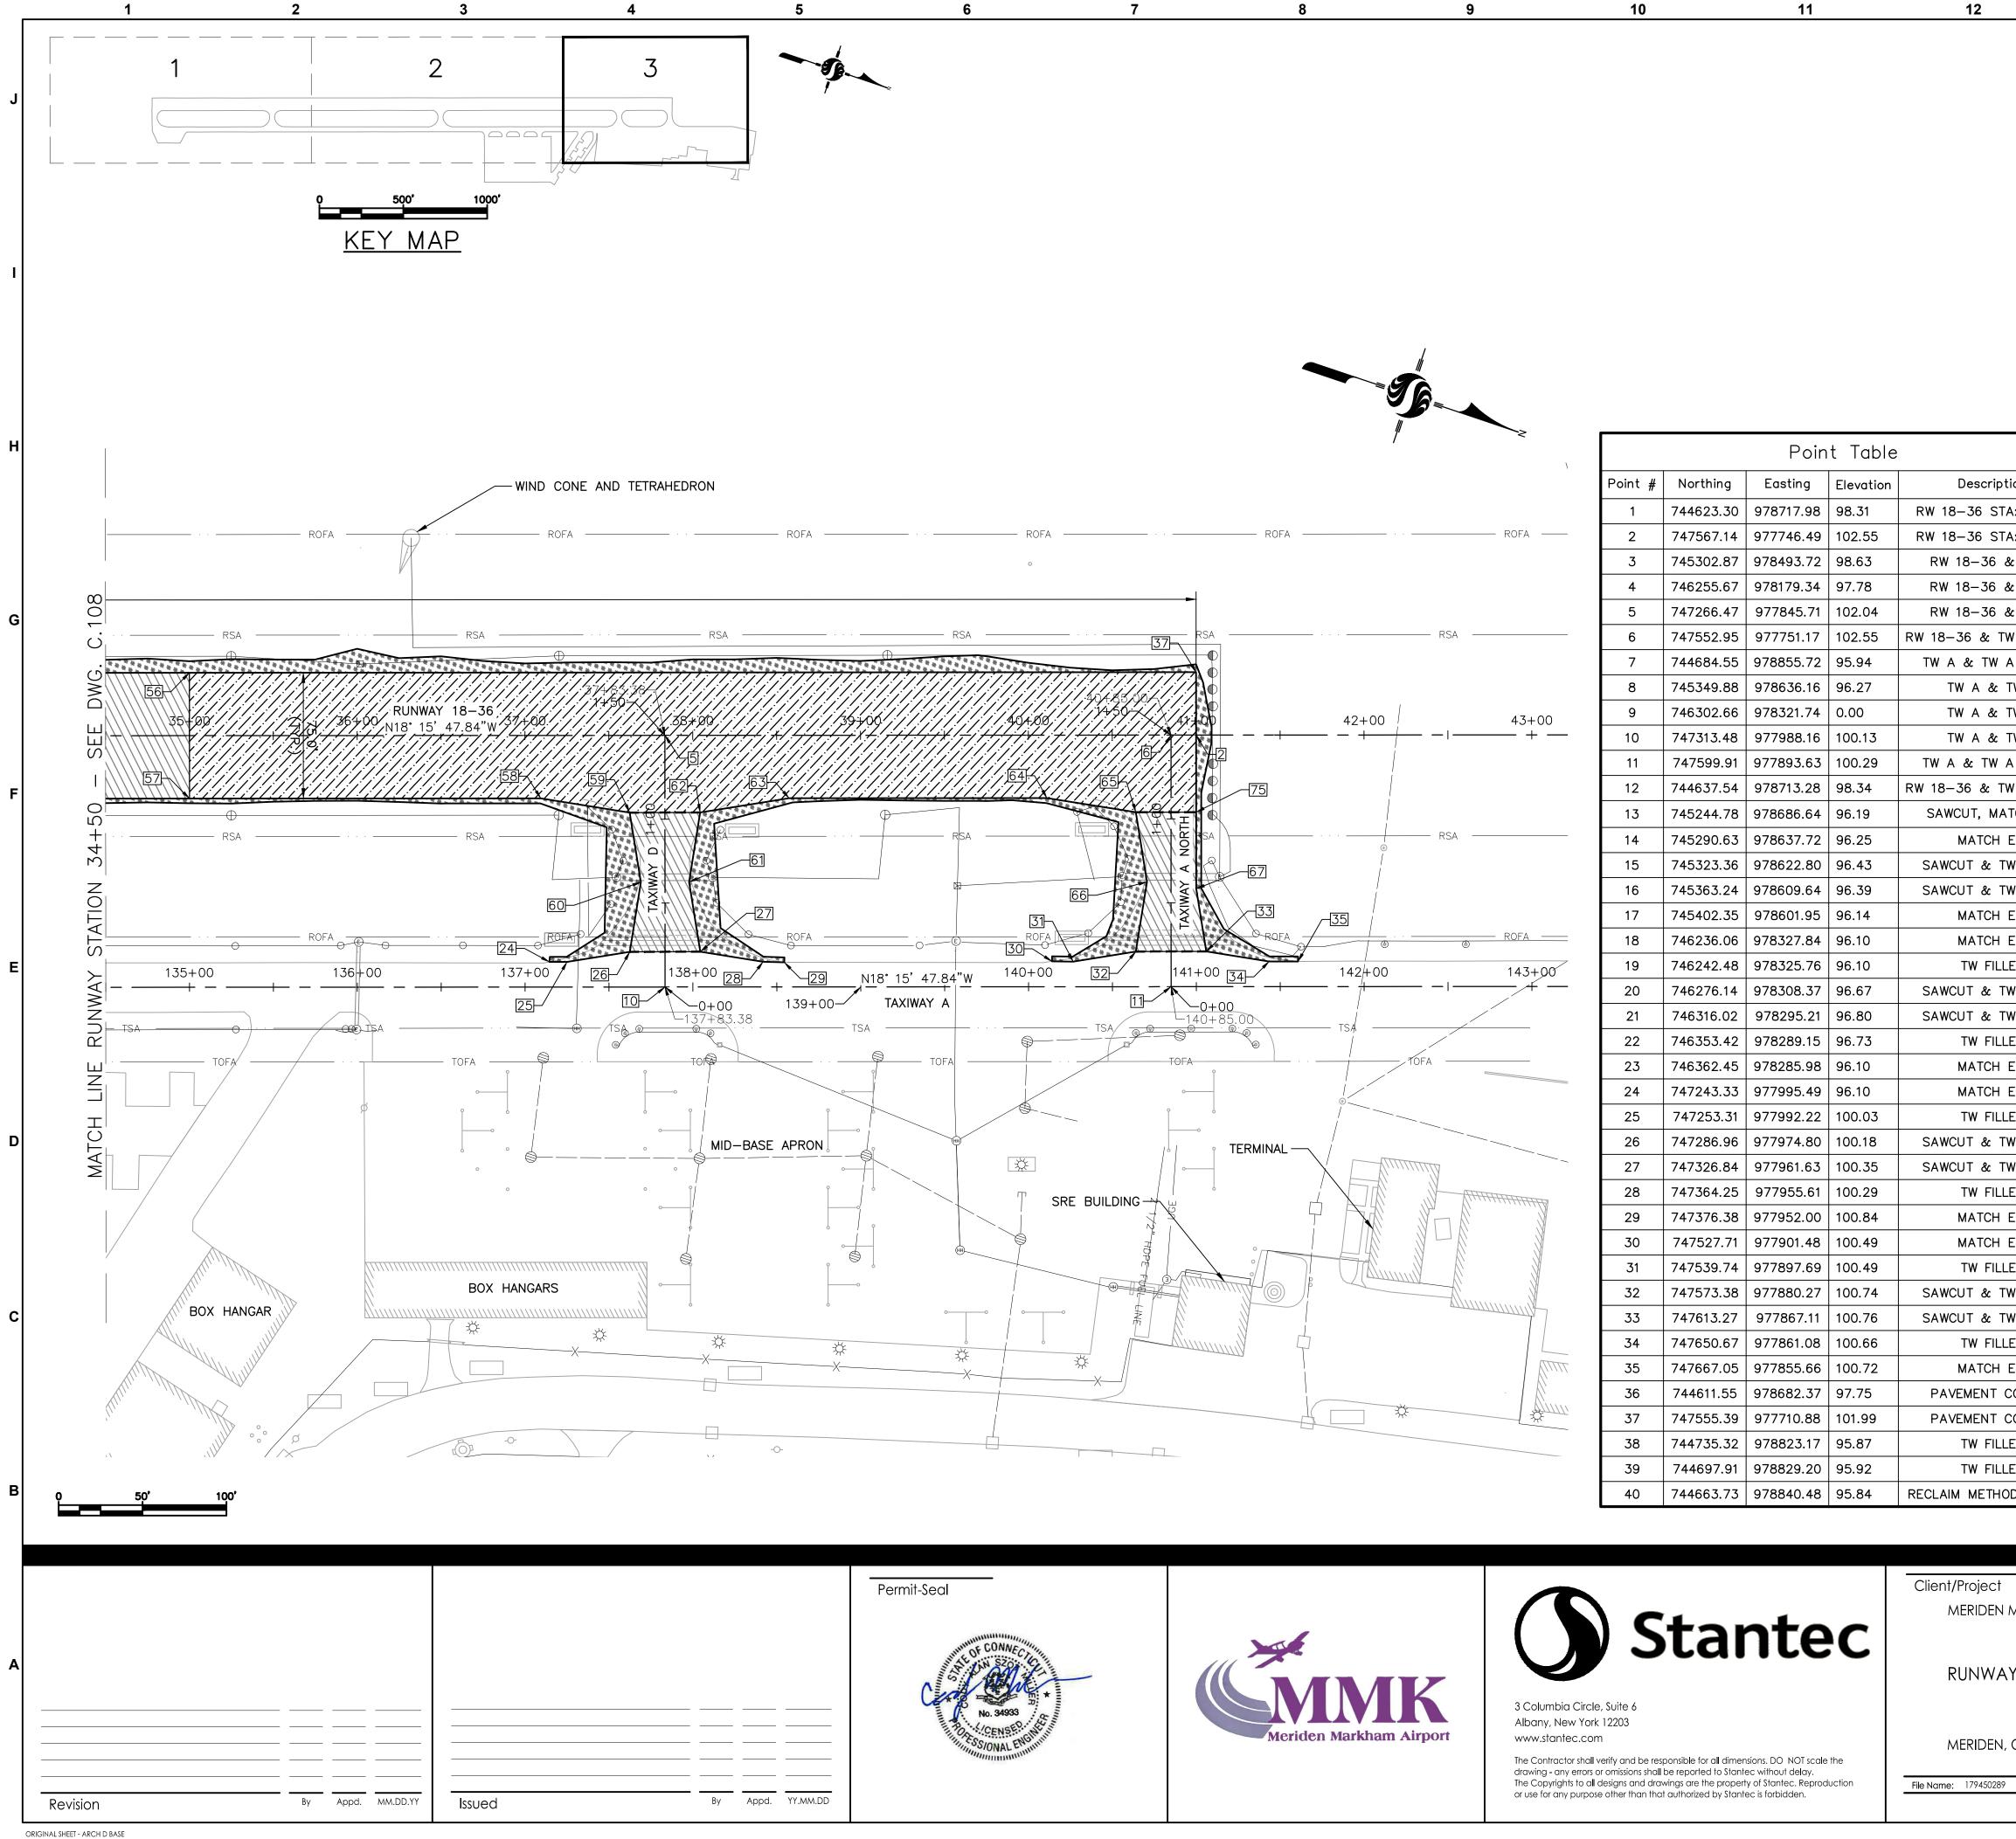

		Poin	t Table					Point	Table
Point #	Northing	Easting	Elevation	Description	Point #	Northing	Easting	Elevation	Description
1	744623.30	978717.98	98.31	RW 18-36 STA: 10+00	41	744678.59	978791.88	96.62	TW FILLET
2	747567.14	977746.49	102.55	RW 18-36 STA: 41+00	42	744671.90	978750.38	97.36	TW FILLET
3	745302.87	978493.72	98.63	RW 18-36 & TW B	43	744719.57	978725.70	97.92	TW FILLET
4	746255.67	978179.34	97.78	RW 18-36 & TW C	44	745244.35	978552.52	98.16	TW FILLET
5	747266.47	977845.71	102.04	RW 18-36 & TW D	45	745297.35	978543.98	97.76	TW FILLET
6	747552.95	977751.17	102.55	RW 18-36 & TW A NORTH	46	745316.67	978581.30	97.01	TW FILLET
7	744684.55	978855.72	95.94	TW A & TW A SOUTH	47	745343.91	978572.31	97.03	TW FILLET
8	745349.88	978636.16	96.27	TW A & TW B	48	745337.23	978530.82	97.77	TW FILLET
9	746302.66	978321.74	0.00	TW A & TW C	49	745384.90	978506.14	97.96	TW FILLET
10	747313.48	977988.16	100.13	TW A & TW D	50	746197.13	978238.09	96.95	TW FILLET
11	747599.91	977893.63	100.29	TW A & TW A NORTH	51	746250.12	978229.56	97.05	TW FILLET
12	744637.54	978713.28	98.34	RW 18-36 & TW A NORTH	52	746269.48	978267.07	96.88	TW FILLET
13	745244.78	978686.64	96.19	SAWCUT, MATCH EX.	53	746296.69	978257.89	96.89	TW FILLET
14	745290.63	978637.72	96.25	MATCH EX.	54	746290.01	978216.39	97.10	TW FILLET
15	745323.36	978622.80	96.43	SAWCUT & TW FILLET	55	746337.68	978191.71	97.52	TW FILLET
16	745363.24	978609.64	96.39	SAWCUT & TW FILLET	56	746985.61	977898.91	100.35	CHANGE RECLAIM METHOD
17	745402.35	978601.95	96.14	MATCH EX.	57	747009.12	977970.13	100.35	CHANGE REECLAIM METHOD
18	746236.06	978327.84	96.10	MATCH EX.	58	747207.95	977904.51	101.19	TW FILLET
19	746242.48	978325.76	96.10	TW FILLET	59	747260.94	977895.98	101.25	TW FILLET & CHANGE IN RECLAIM METHOD
20	746276.14	978308.37	96.67	SAWCUT & TW FILLET	60	747280.27	977933.30	100.66	TW FILLET
21	746316.02	978295.21	96.80	SAWCUT & TW FILLET	61	747307.51	977924.31	100.66	TW FILLET
22	746353.42	978289.15	96.73	TW FILLET	62	747300.83	977882.81	101.31	TW FILLET & CHANGE RECLAIM METHOD
23	746362.45	978285.98	96.10	MATCH EX.	63	747348.50	977858.13	101.77	TW FILLET
24	747243.33	977995.49	96.10	MATCH EX.	64	747494.38	977809.99	101.99	TW FILLET
25	747253.31	977992.22	100.03	TW FILLET	65	747547.37	977801.45	101.88	TW FILLET & CHANGE RECLAIM METHOD
26	747286.96	977974.80	100.18	SAWCUT & TW FILLET	66	747566.70	977838.78	101.12	TW FILLET
27	747326.84	977961.63	100.35	SAWCUT & TW FILLET	67	747595.84	977833.46	101.06	TW FILLET
28	747364.25	977955.61	100.29	TW FILLET	68	744670.31	978860.42	95.87	PAVEMENT CORNER
29	747376.38	977952.00	100.84	MATCH EX.	69	744727.55	978927.36	94.88	PAVEMENT CORNER
30	747527.71	977901.48	100.49	MATCH EX.	70	744854.07	978885.61	95.10	PAVEMENT CORNER
31	747539.74	977897.69	100.49	TW FILLET	71	744862.68	978827.25	95.87	PAVEMENT EDGE
32	747573.38	977880.27	100.74	SAWCUT & TW FILLET	72	744879.58	978807.16	96.10	PAVEMENT EDGE
33	747613.27	977867.11	100.76	SAWCUT & TW FILLET	73	744887.41	978830.90	0.00	RADIUS CENTER
34	747650.67	977861.08	100.66	TW FILLET	74	745235.38	978658.15	96.25	SAWCUT, MATCH EX.
35	747667.05	977855.66	100.72	MATCH EX.	75	747581.56	977790.17	101.72	CHANGE RECLAIM METHOD
36	744611.55	978682.37	97.75	PAVEMENT CORNER					
37	747555.39	977710.88	101.99	PAVEMENT CORNER					
38	744735.32	978823.17	95.87	TW FILLET					
39	744697.91	978829.20	95.92	TW FILLET					
40	744663.73	978840.48	95.84	RECLAIM METHOD CHANGE					

Client/Project MERIDEN MA


RUNWAY

MERIDEN, CO

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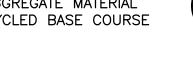
## <u>LEGEND</u>




IN-PLACE FULL DEPTH RECLAMATION 4" HMA ON 7" RECYCLED BASE COURSE

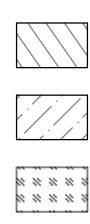14

IN-PLACE FULL DEPTH RECLAMATION WITH CORRECTIVE AGGREGATE MATERIAL 4" HMA ON 7" RECYCLED BASE COURSE



C.107

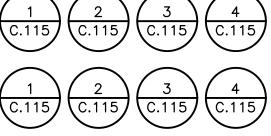


TOPSOIL AND SEED

— — — — — BITUMINOUS JOINT SAW AND SEAL





POINT I.D. #, SEE POINT TABLE, SHEET C.109

-					Title		
ARKHAM MUNICIPAL AIRPORT		PAVEMENT LAYOUT PLAN					
18-36 REHABILITATION				SHEET 3 OF			
ONNECTICUT					Project No. 179450289	Scale AS SHOWN	
		Drawing No.	Sheet	Revision			
	CAM Dwn.	PVE Chkd.	CAM Dsgn.	21.04.07 YY.MM.DD	C.109	13 of 31	

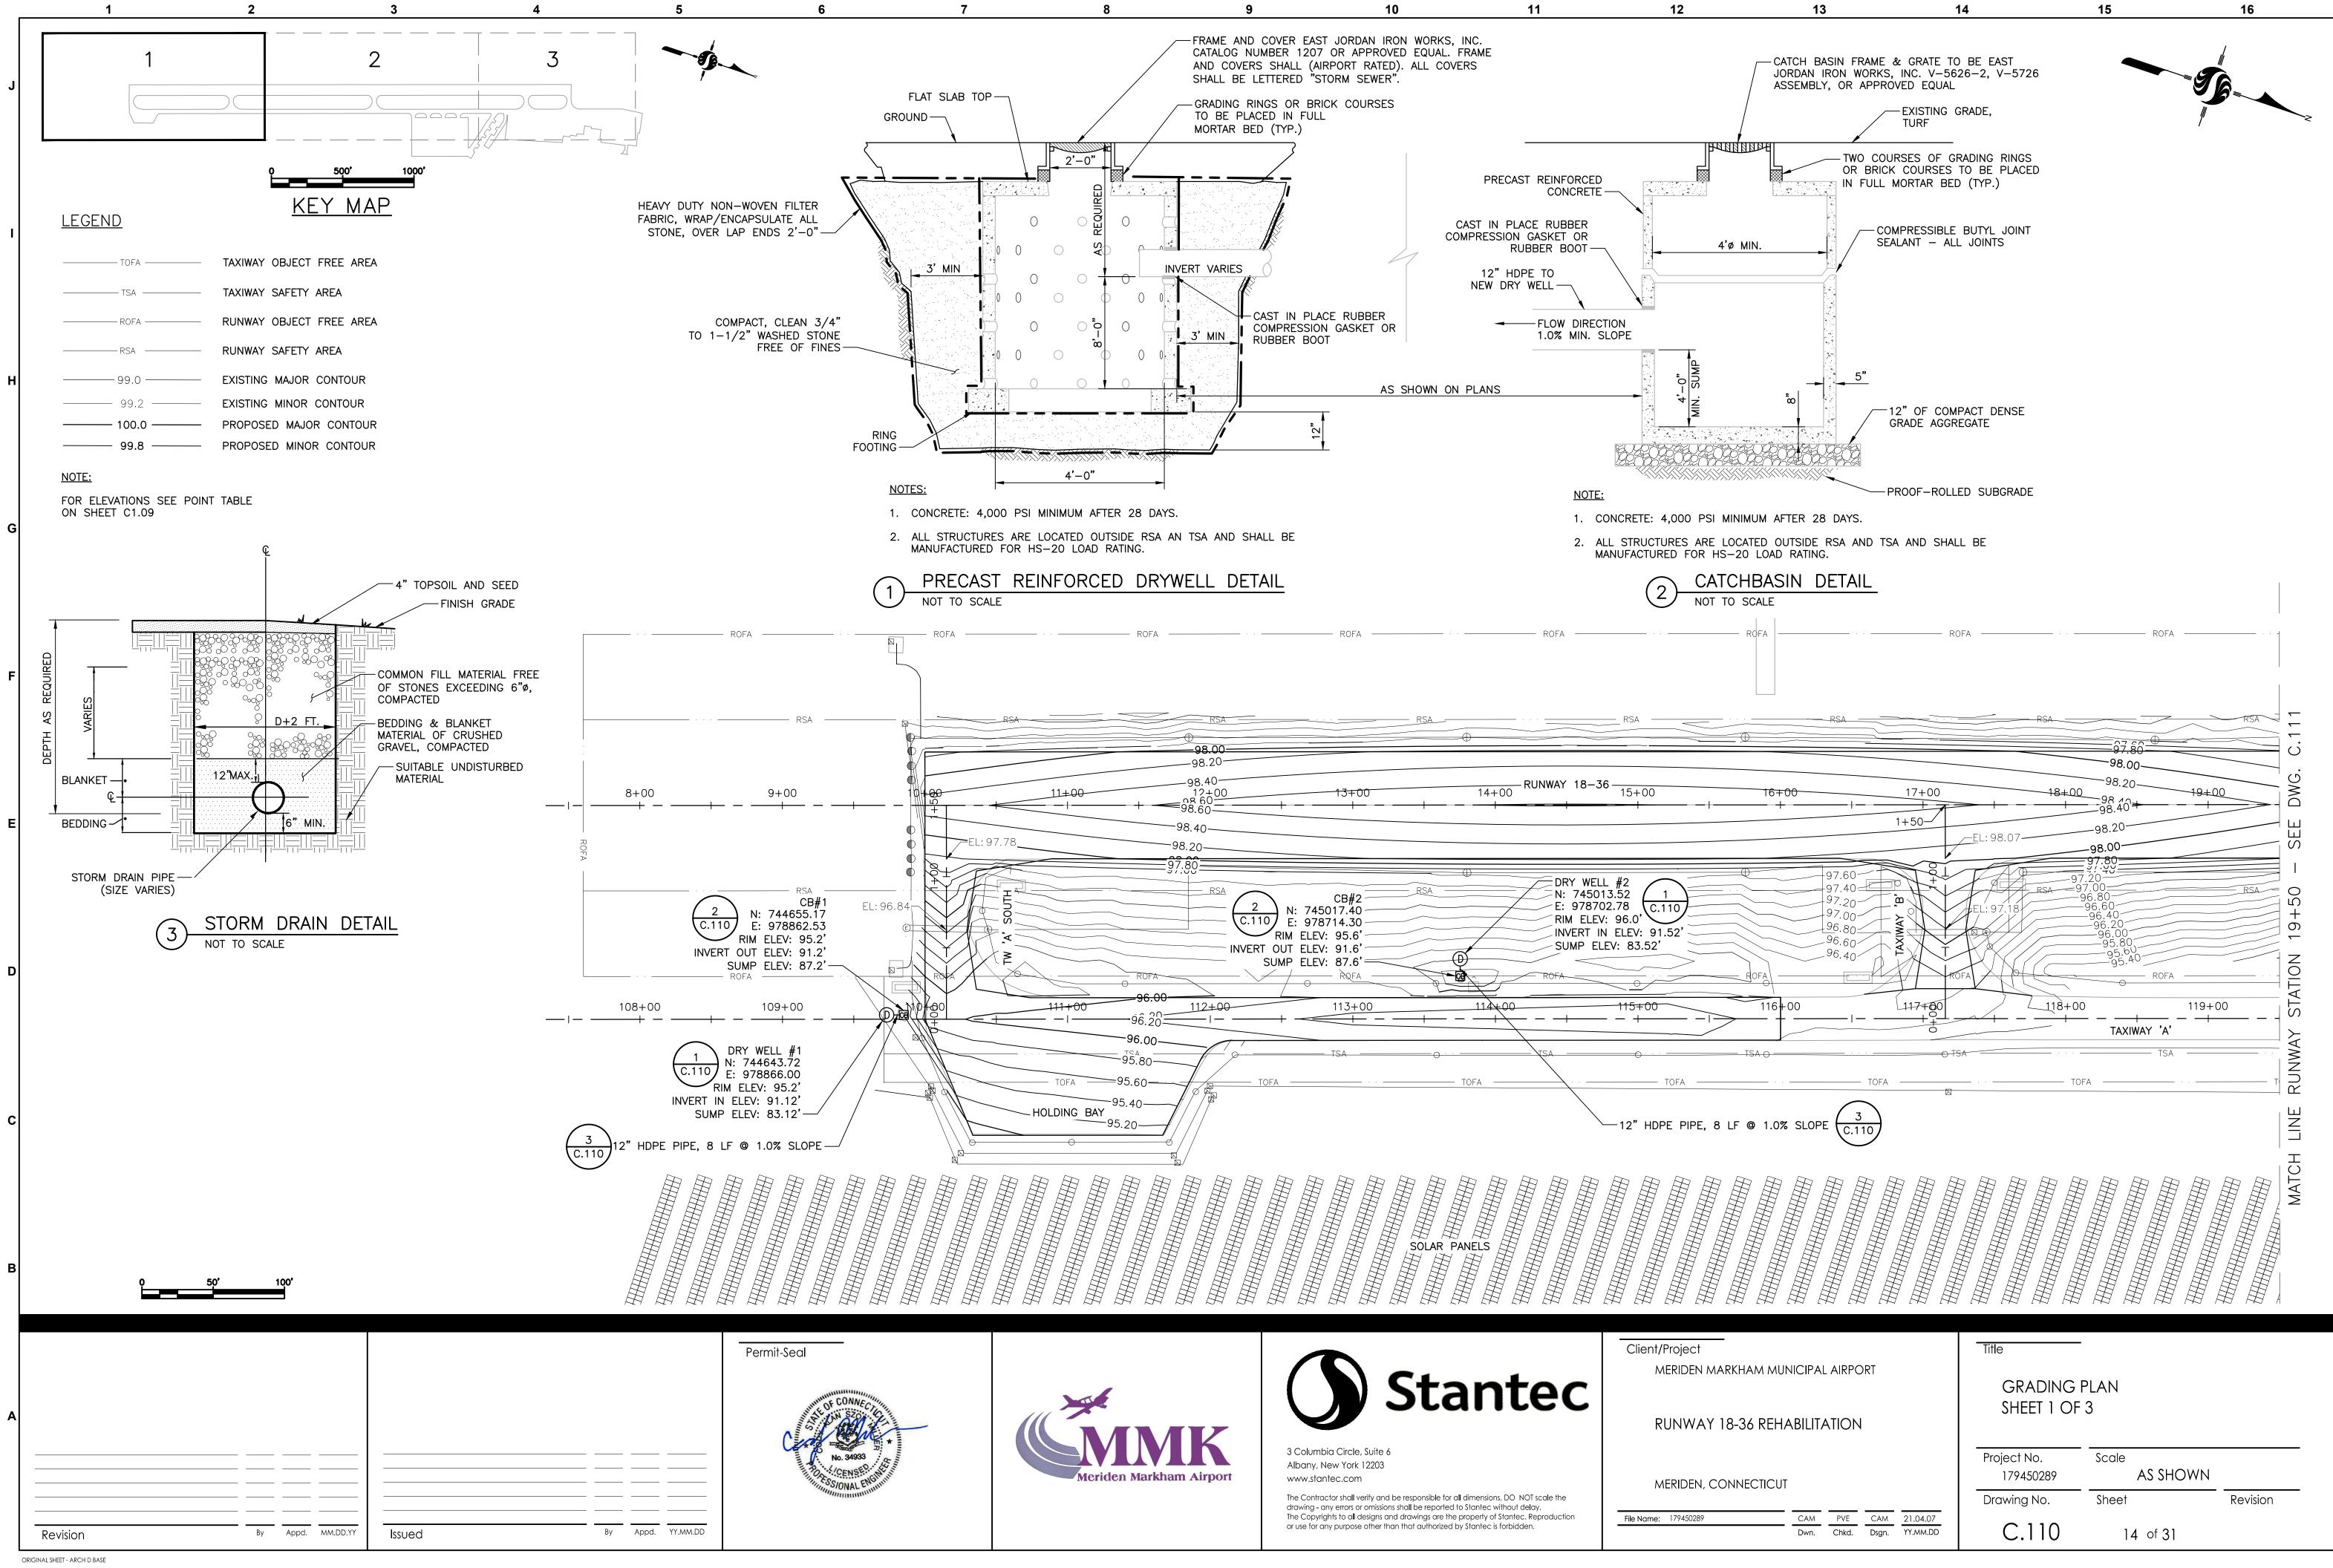

CAM	PVE	CAM	21.04.07
 Dwn.	Chkd.	Dsgn.	YY.MM.DD

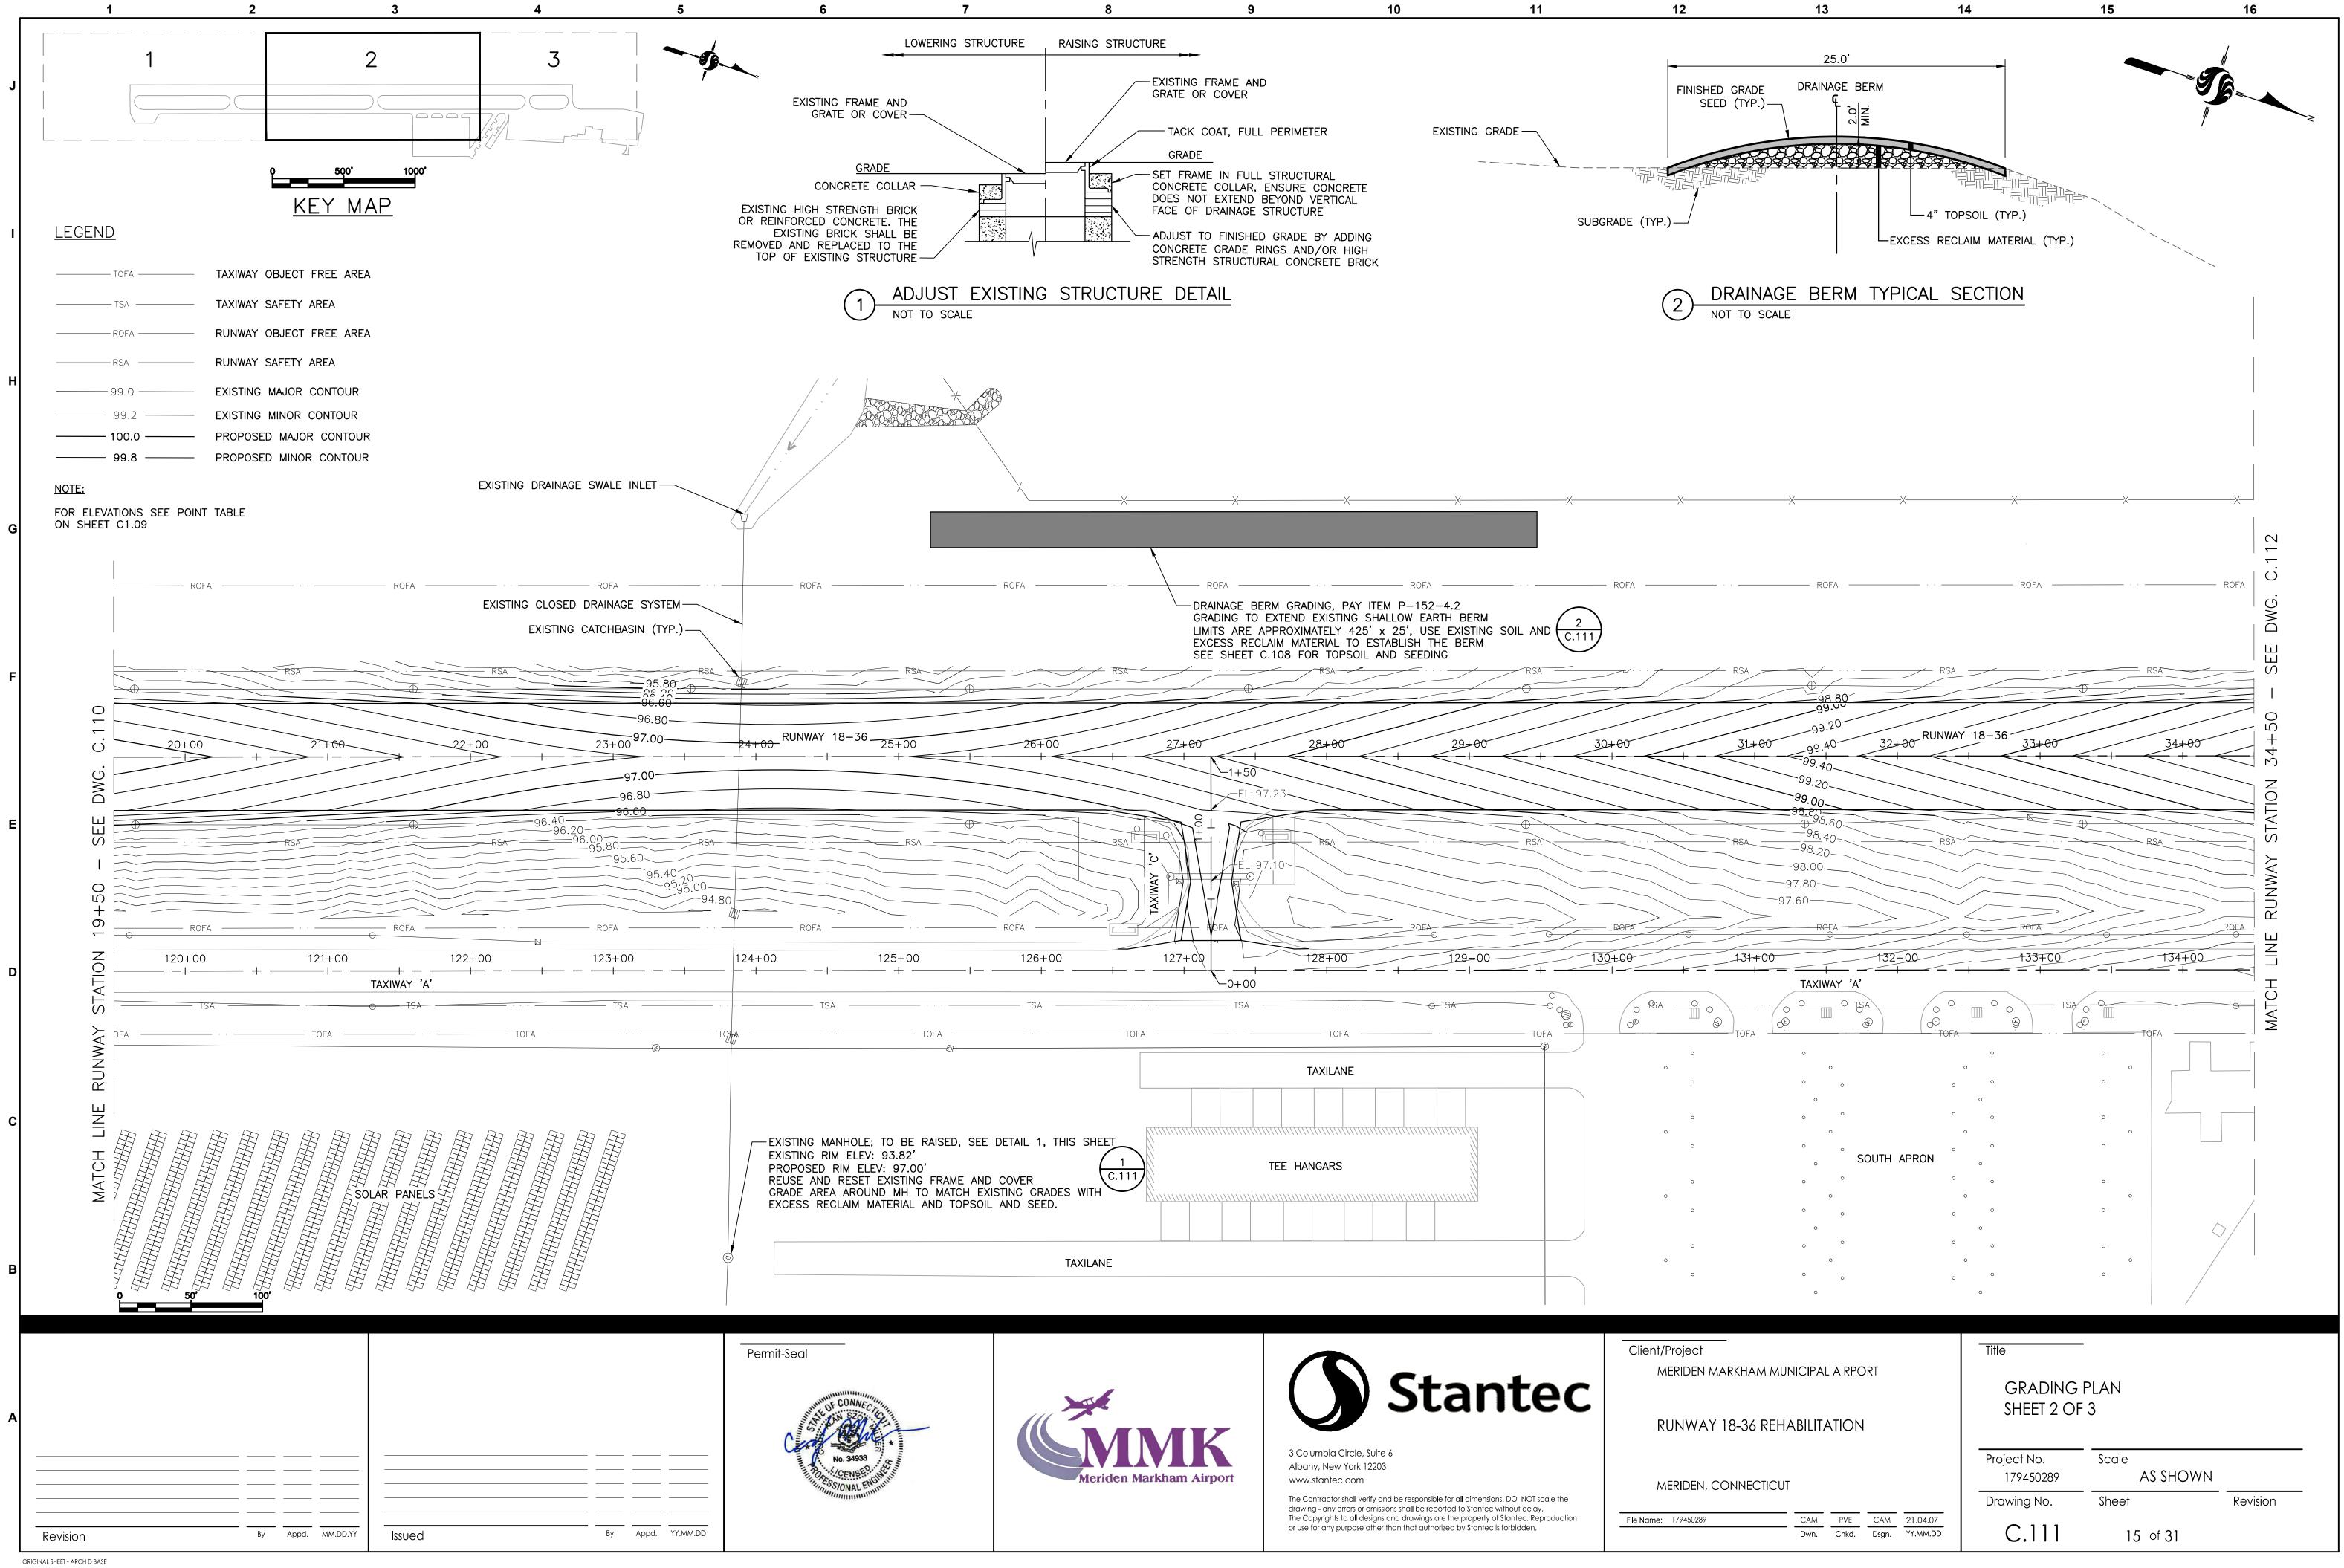

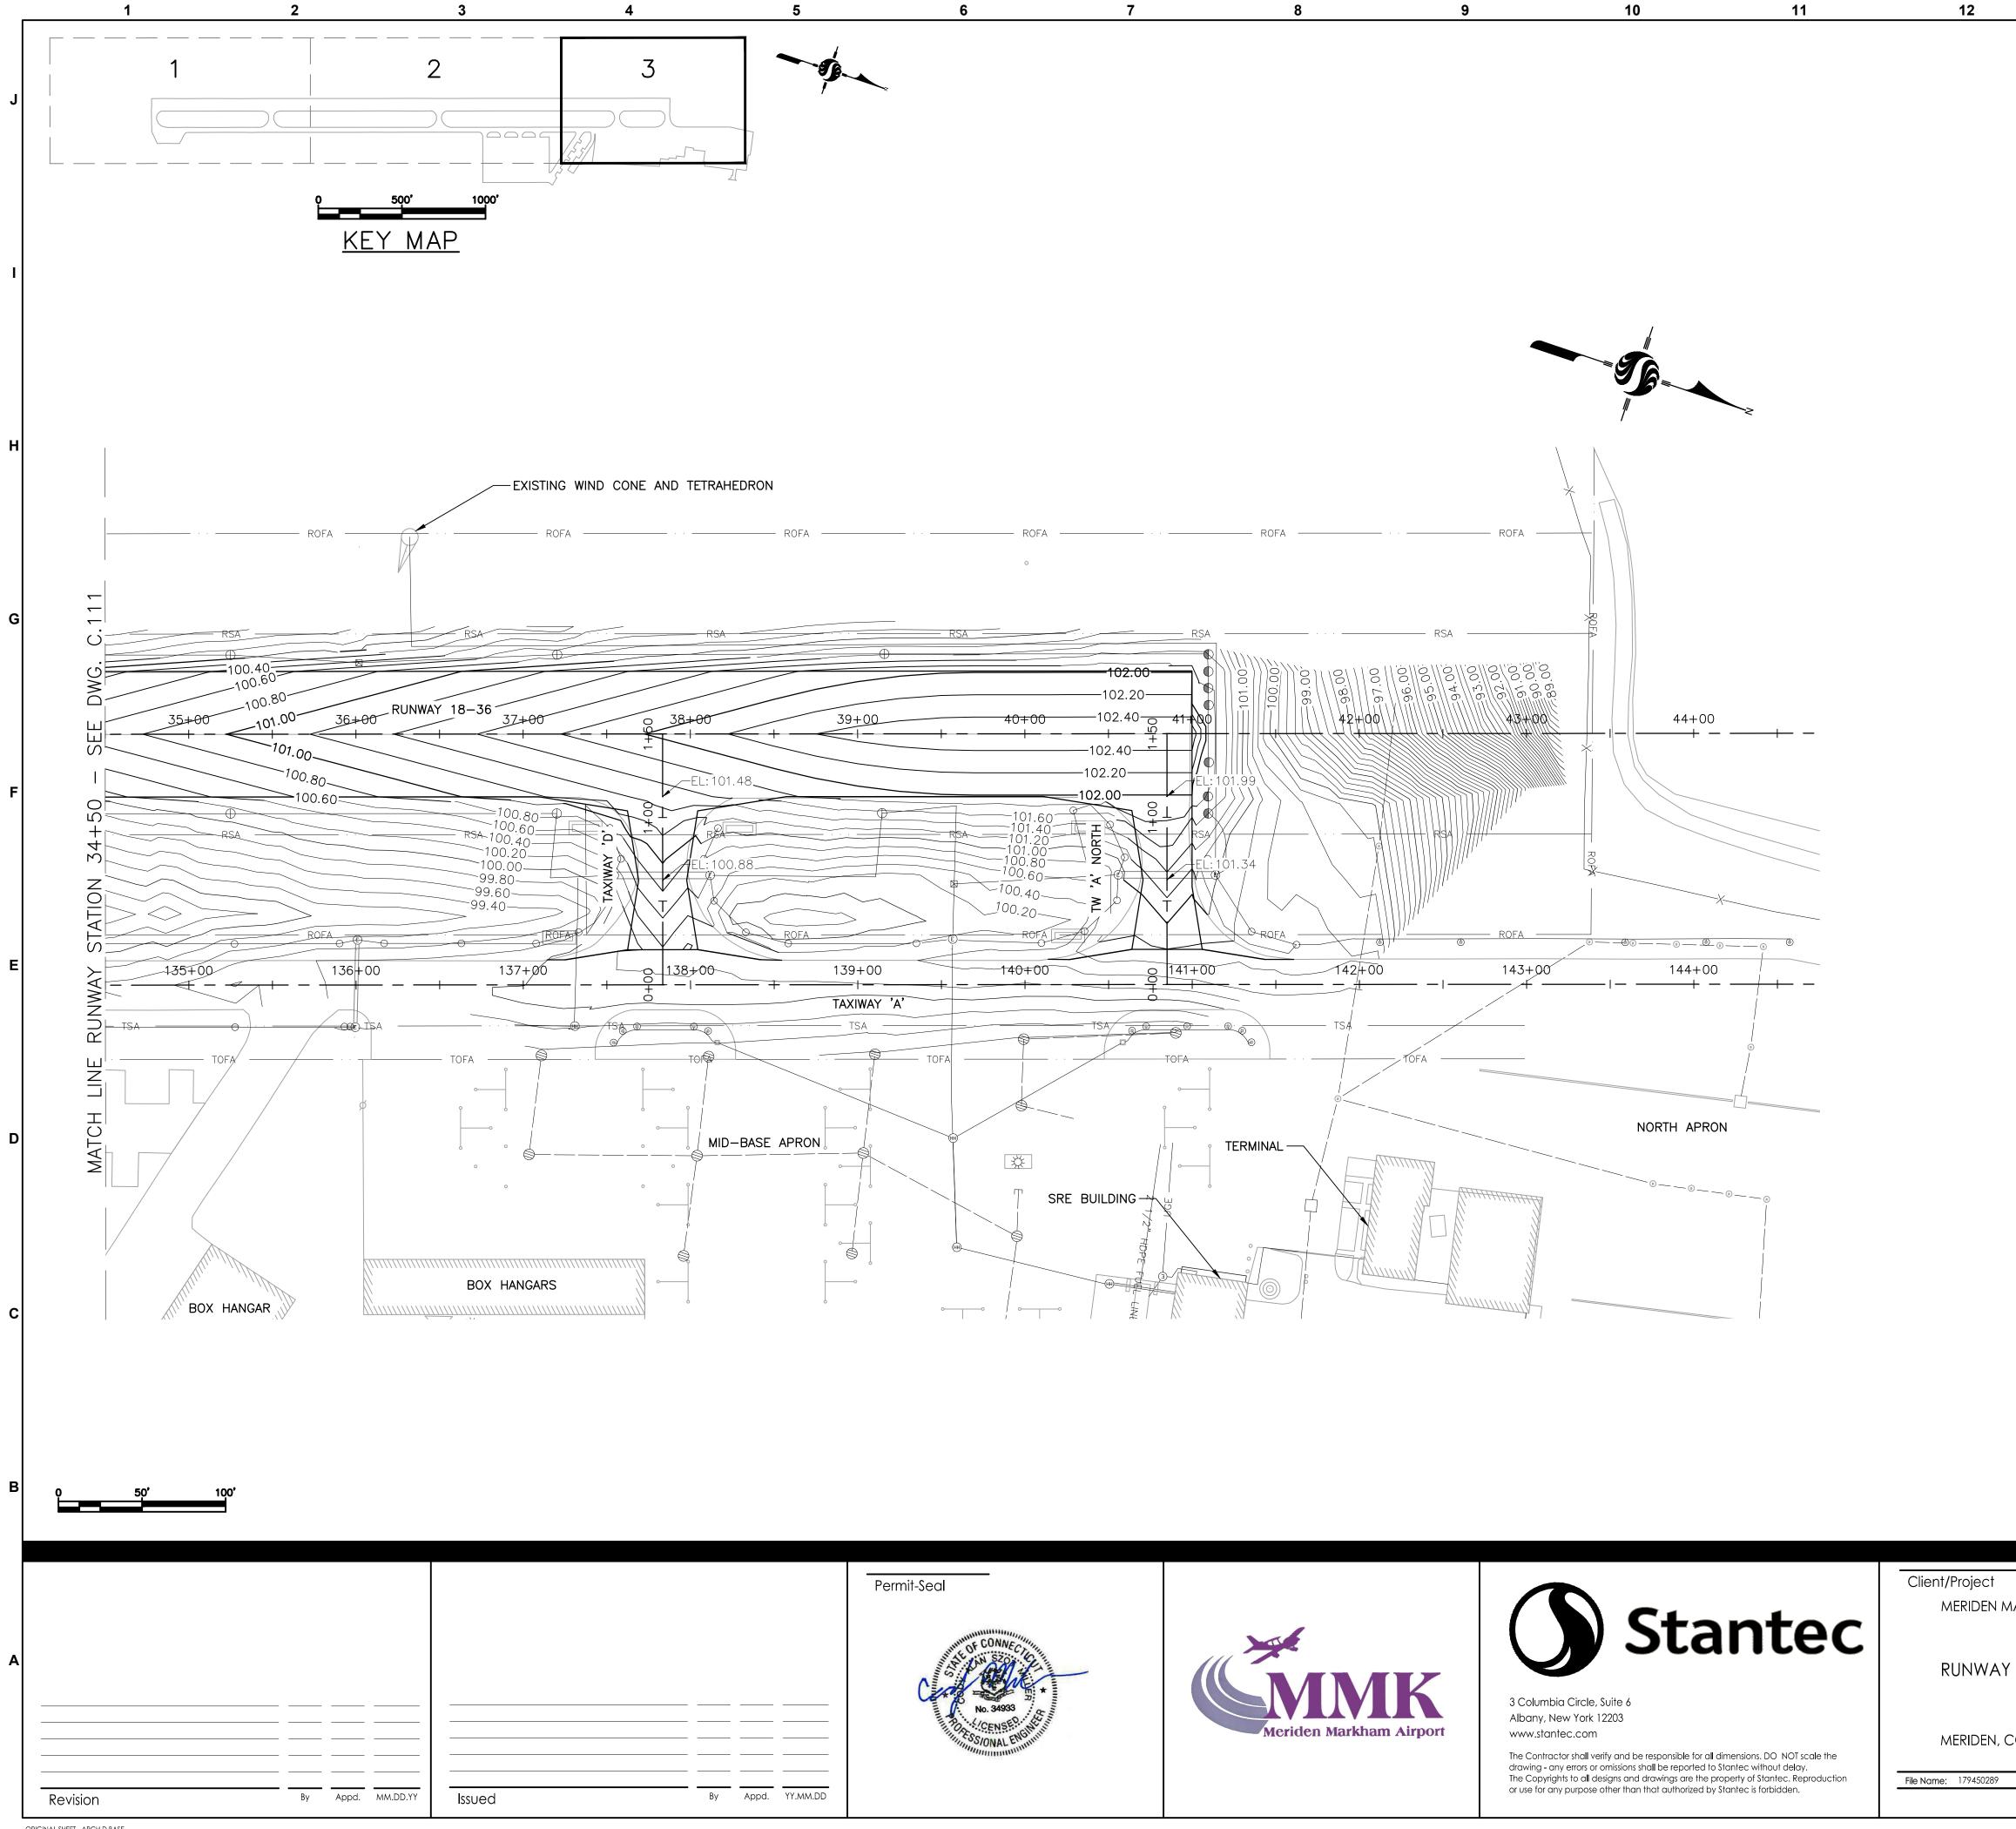

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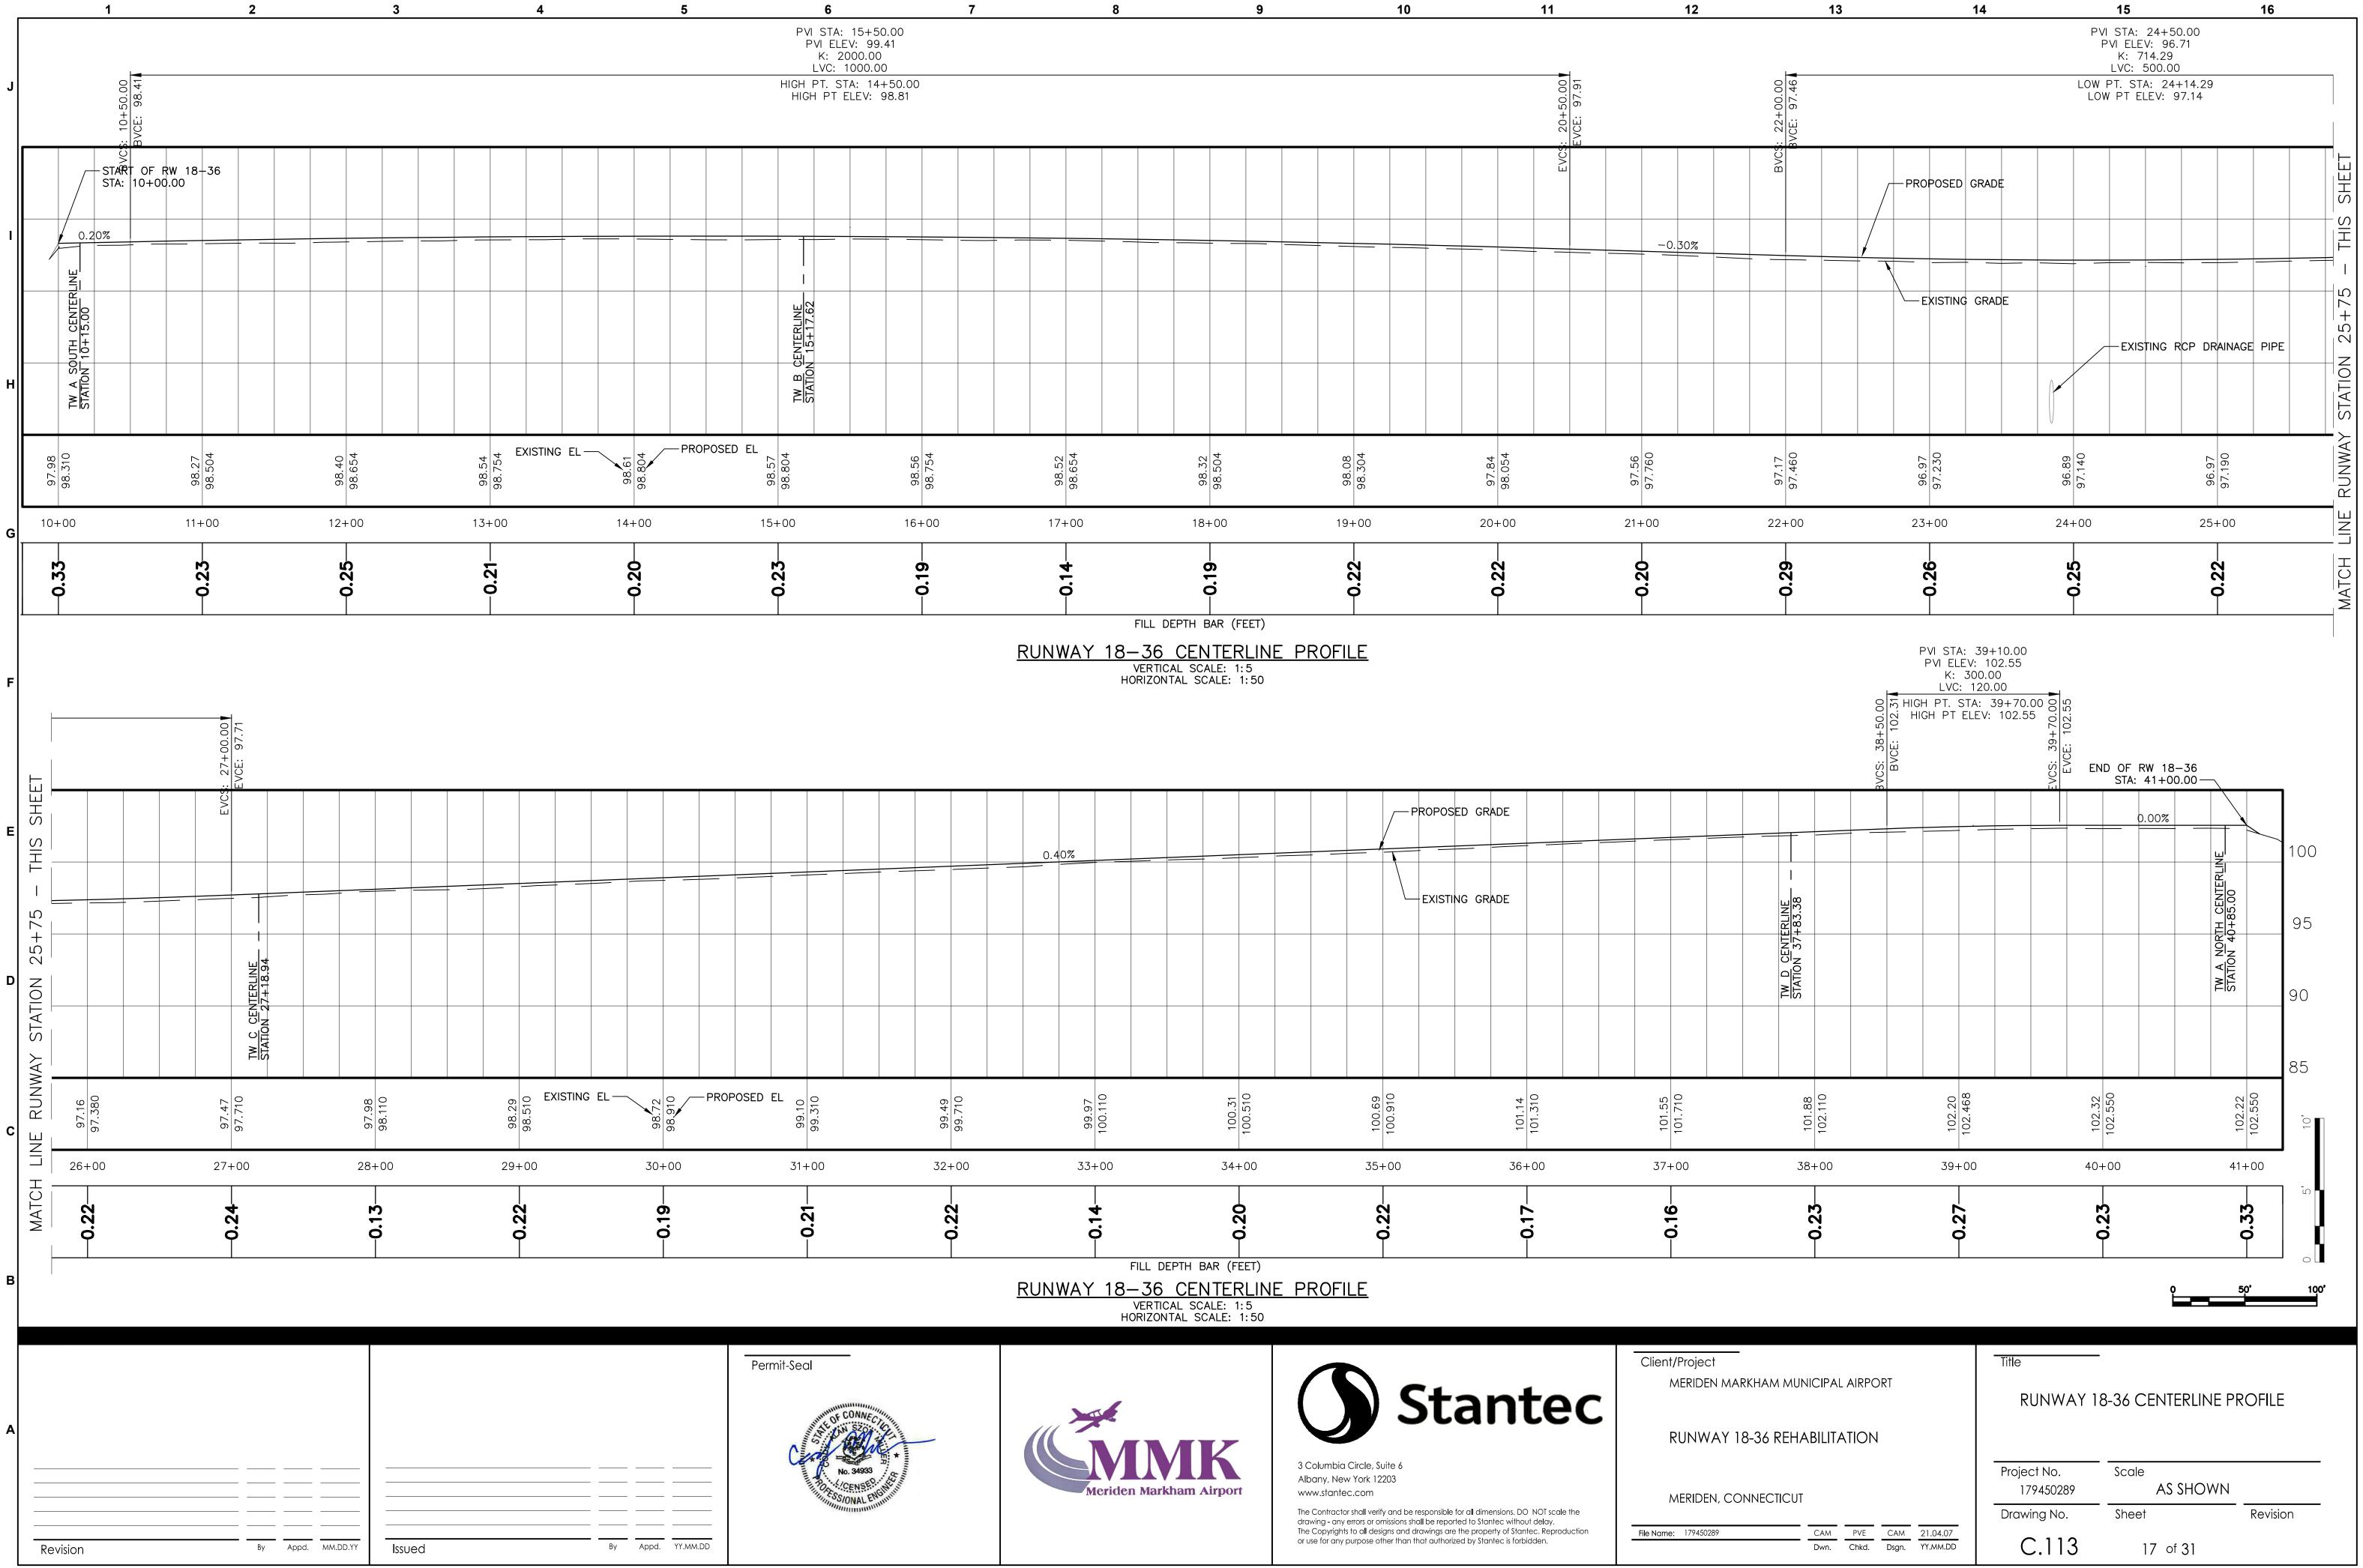
## <u>LEGEND</u>

TOFA	TAXIWAY OBJECT FREE AREA
TSA	TAXIWAY SAFETY AREA
ROFA	RUNWAY OBJECT FREE AREA
	RUNWAY SAFETY AREA
99.0 ——	EXISTING MAJOR CONTOUR
99.2	EXISTING MINOR CONTOUR
—— 100.0 ——	PROPOSED MAJOR CONTOUR
99.8	PROPOSED MINOR CONTOUR

<u>NOTE:</u>


FOR ELEVATIONS SEE POINT TABLE ON SHEET C1.09


_	Title	-		
ARKHAM MUNICIPAL AIRPORT	GRADING	PLAN		
18-36 REHABILITATION	Sheet 3 Of	= 3		
CONNECTICUT	Project No. 179450289	Scale AS SHOWN		
	Drawing No.	Sheet	Revision	
CAMPVECAM21.04.07Dwn.Chkd.Dsgn.YY.MM.DD	C.112	16 of 31		








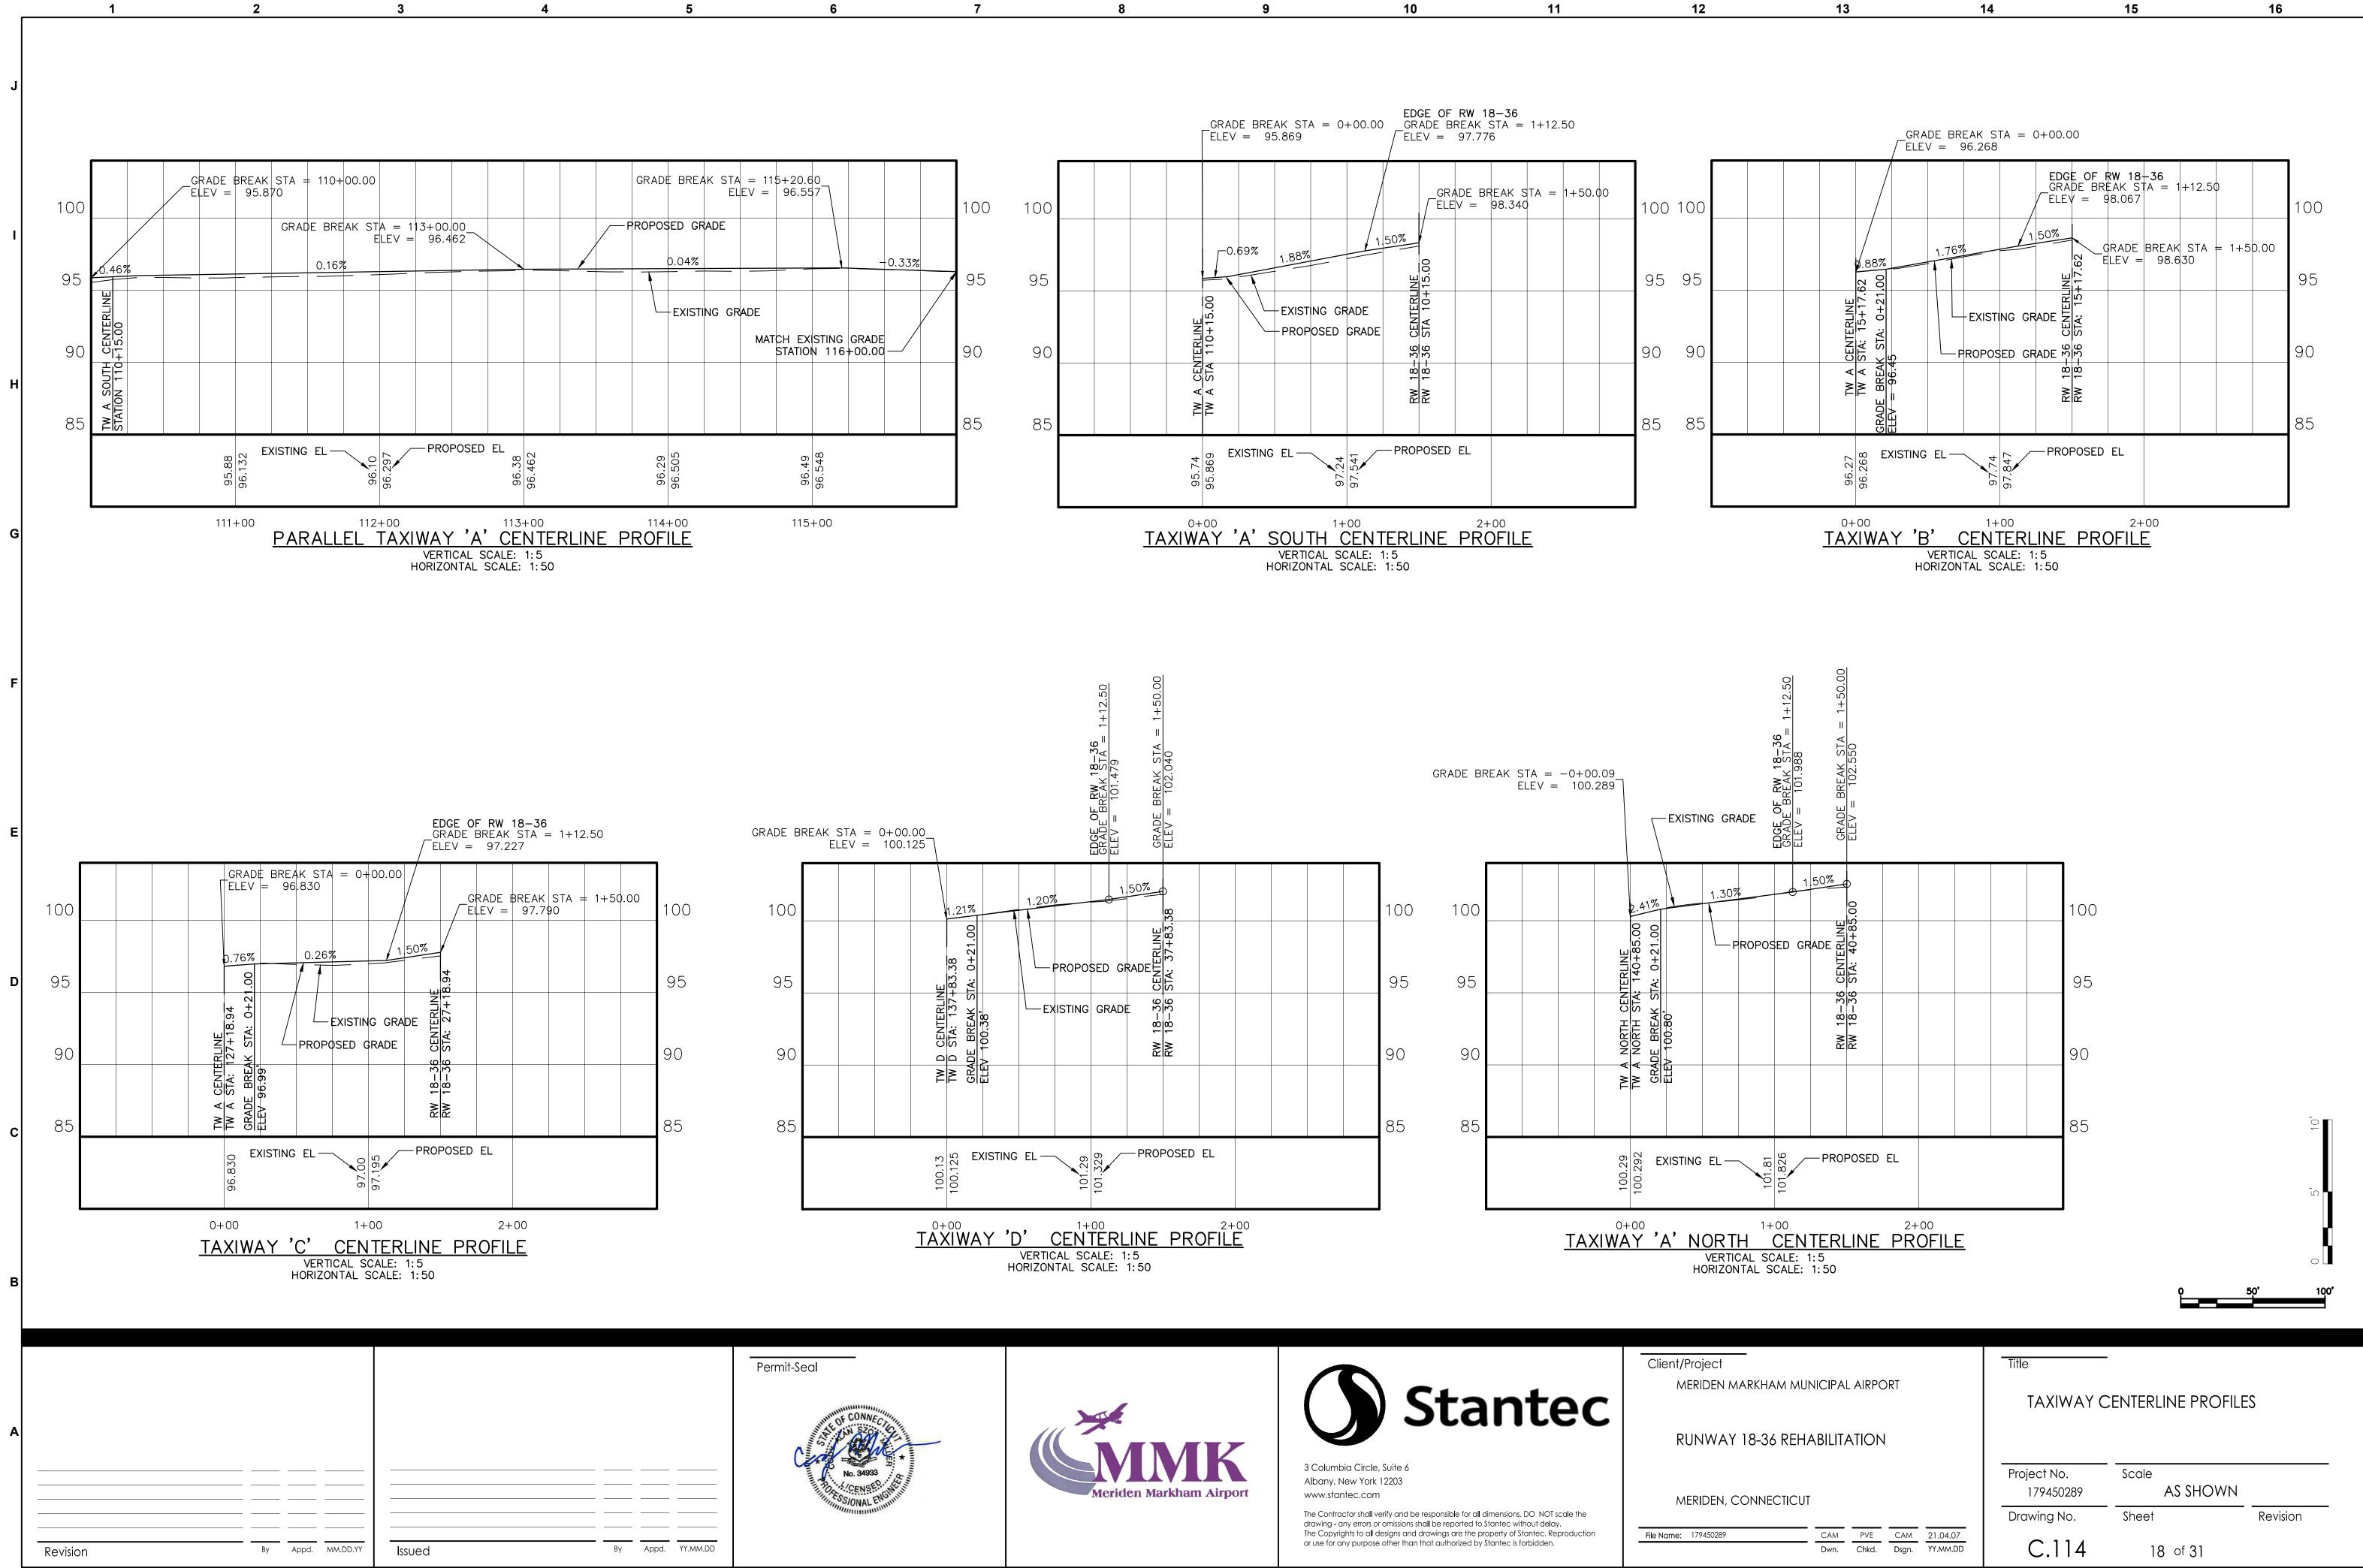


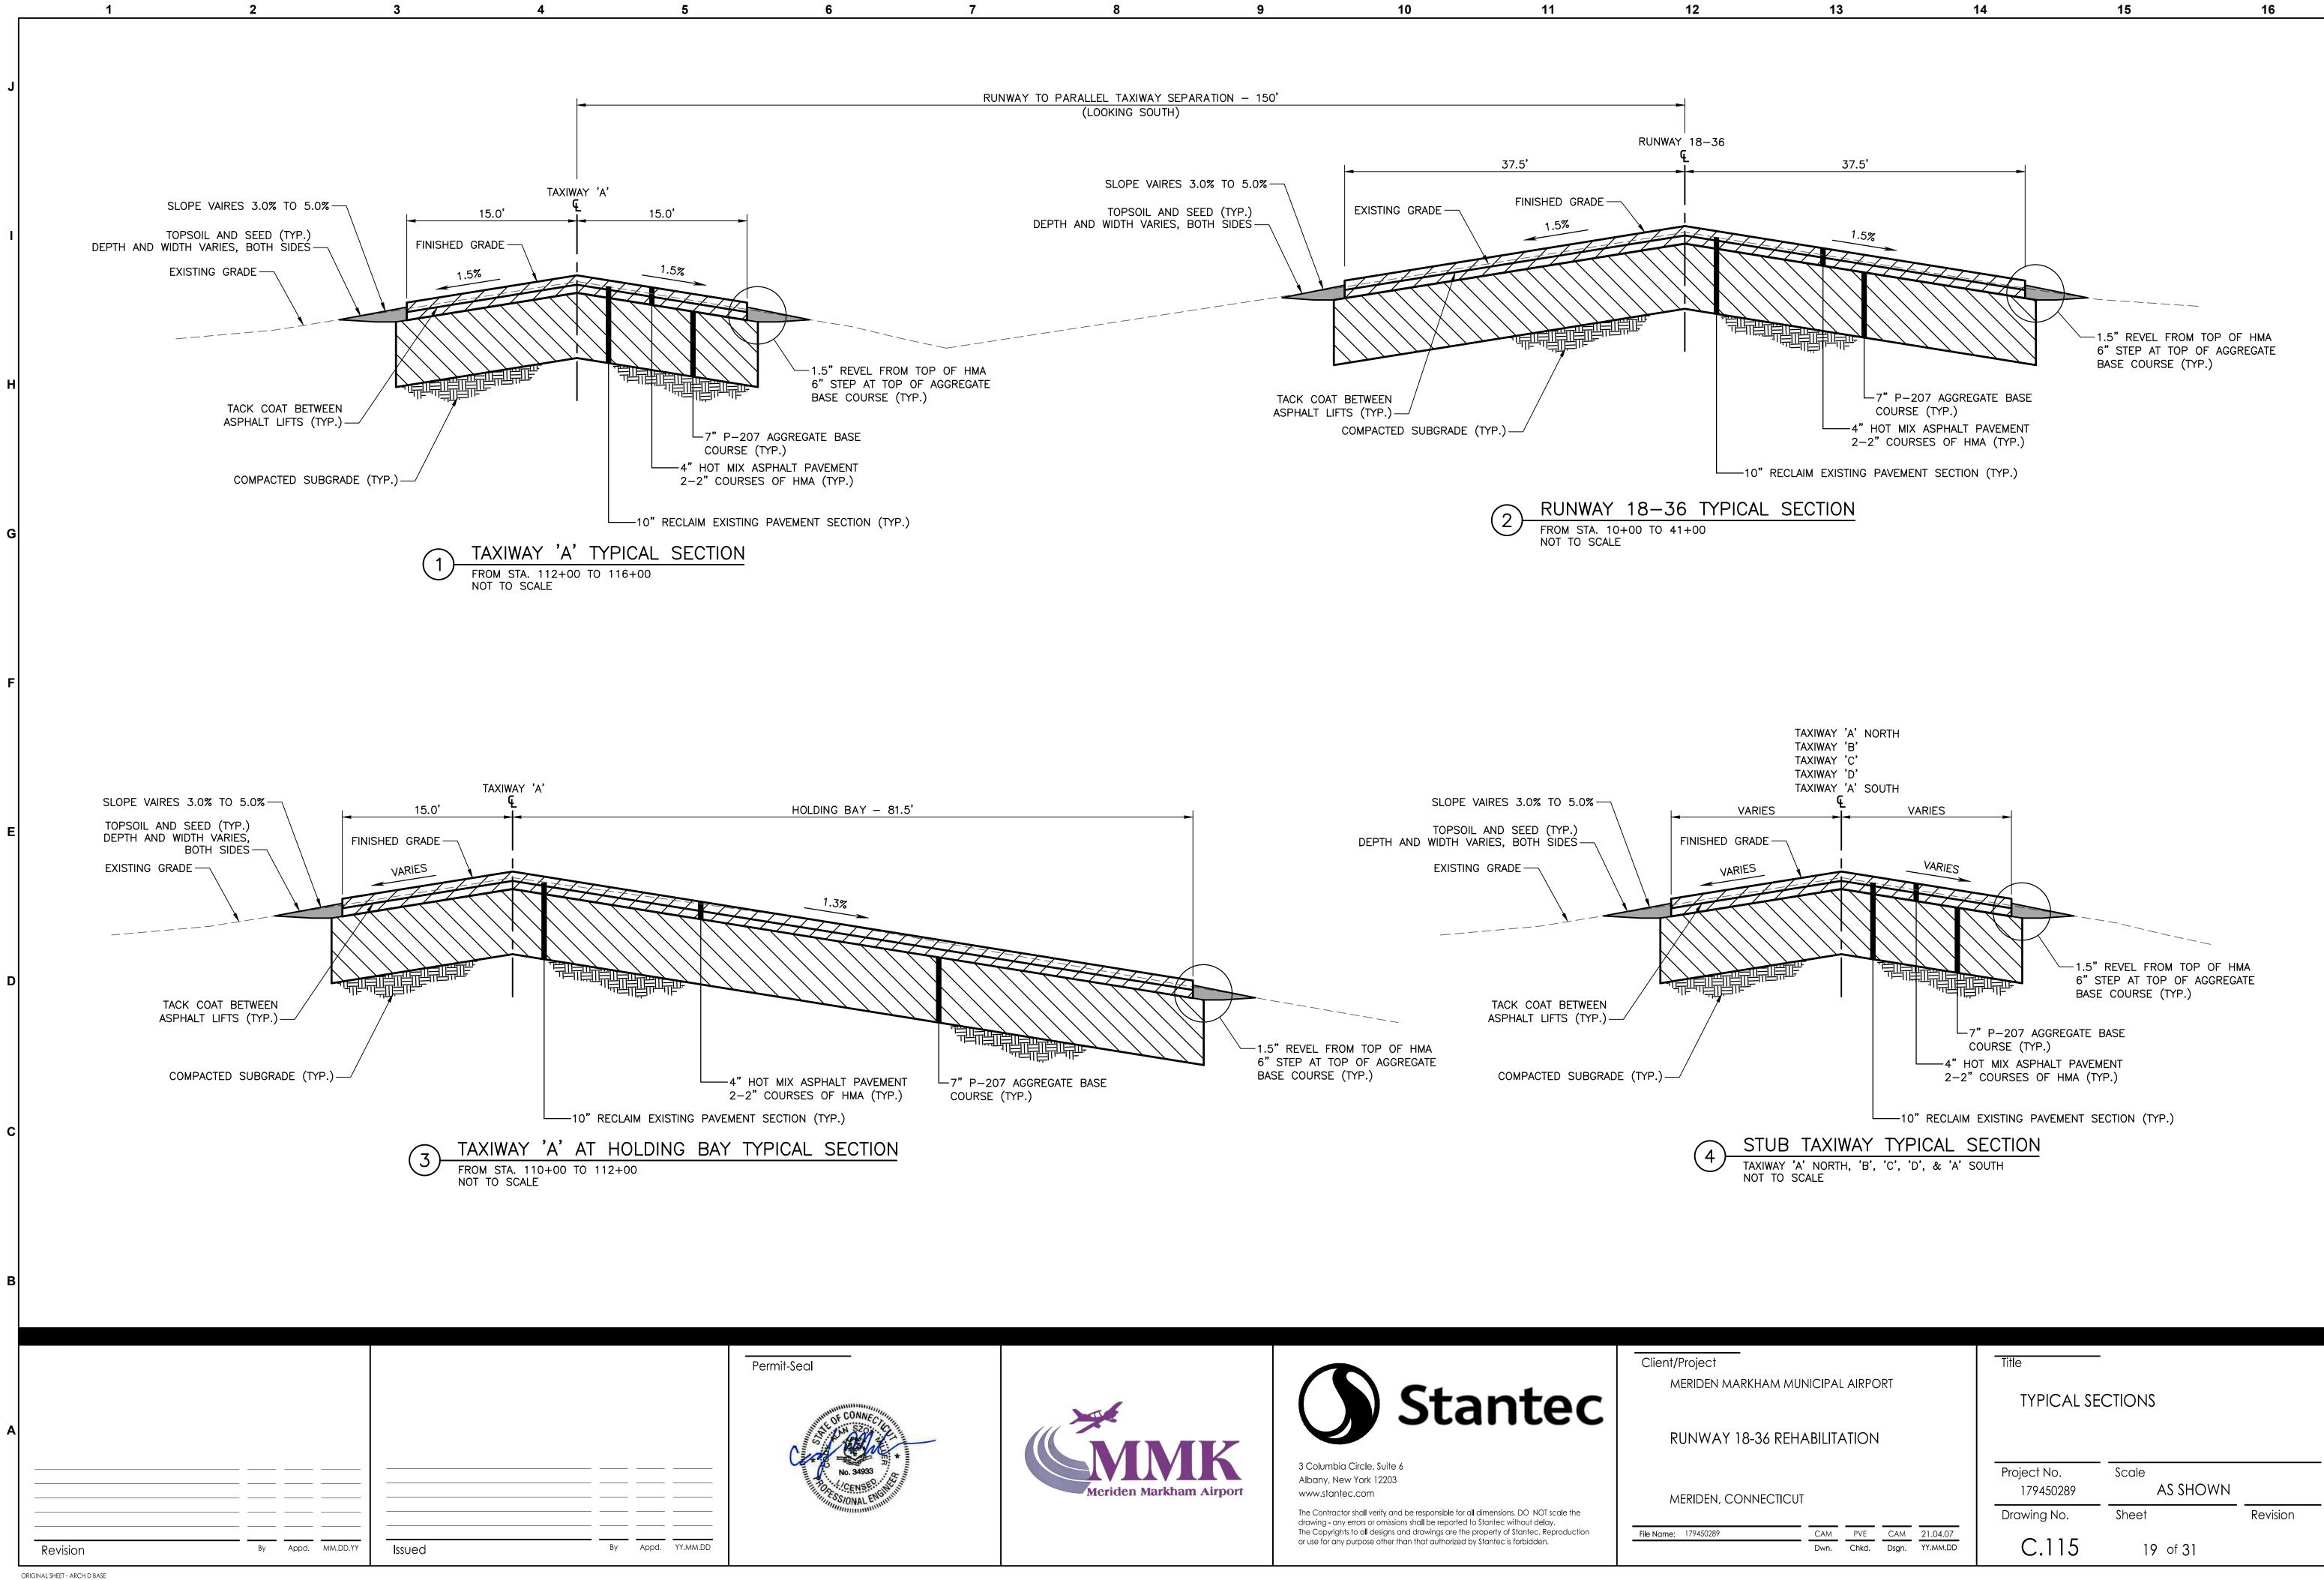

CO 4" HOT	URSE (TYP.) MIX ASPHALT PAVEM COURSES OF HMA (TY	1ENT	
10" RECLAIM E	xisting pavement si ECTION	ECTION (TYP.)	
TAXIWAY 'A' NORTH, 'B', 'C', 'D', & 'A' SO NOT TO SCALE	UTH		
_	Title		
ARKHAM MUNICIPAL AIRPORT	TYPICAL SE	CTIONS	
18-36 REHABILITATION			
CONNECTICUT	Project No. 179450289	Scale AS SHOWN	
CAM PVE CAM 21.04.07	Drawing No.	Sheet	Revision
Dwn. Chkd. Dsgn. YY.MM.DD	C.115	19 of 31	

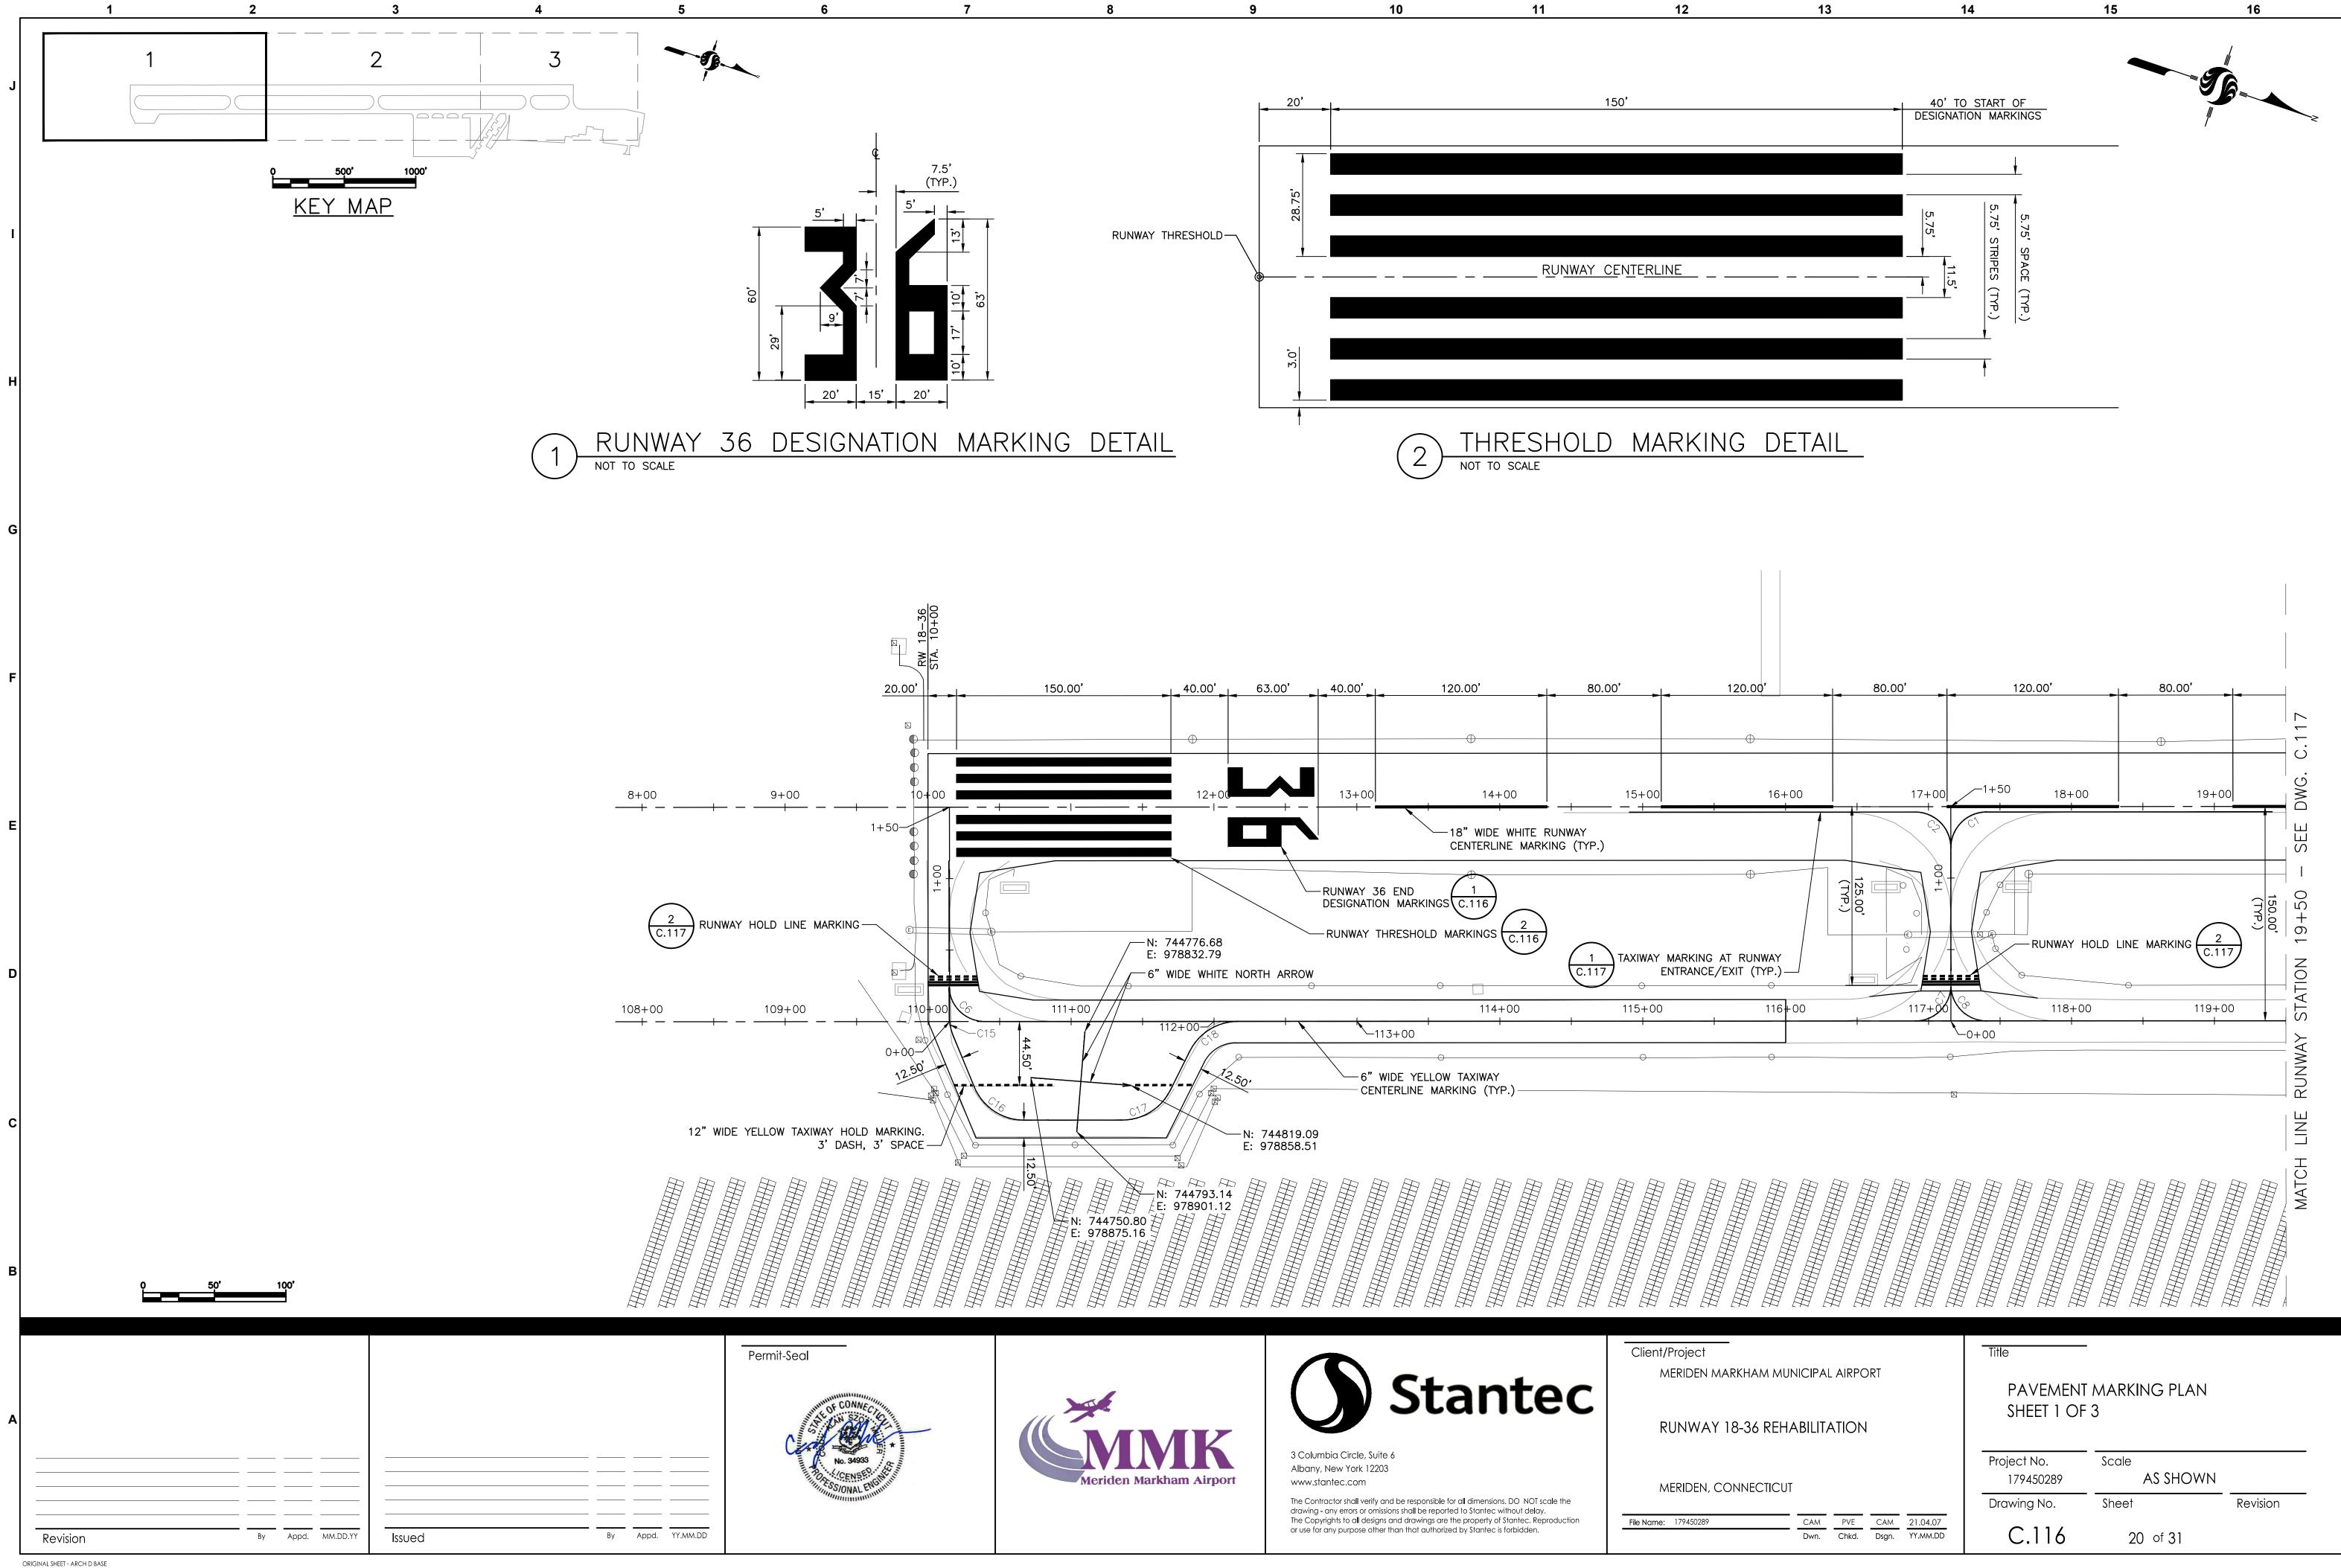


САМ	PVE	CAM	21.04.07
Dwn.	Chkd.	Dsgn.	YY.MM.DD

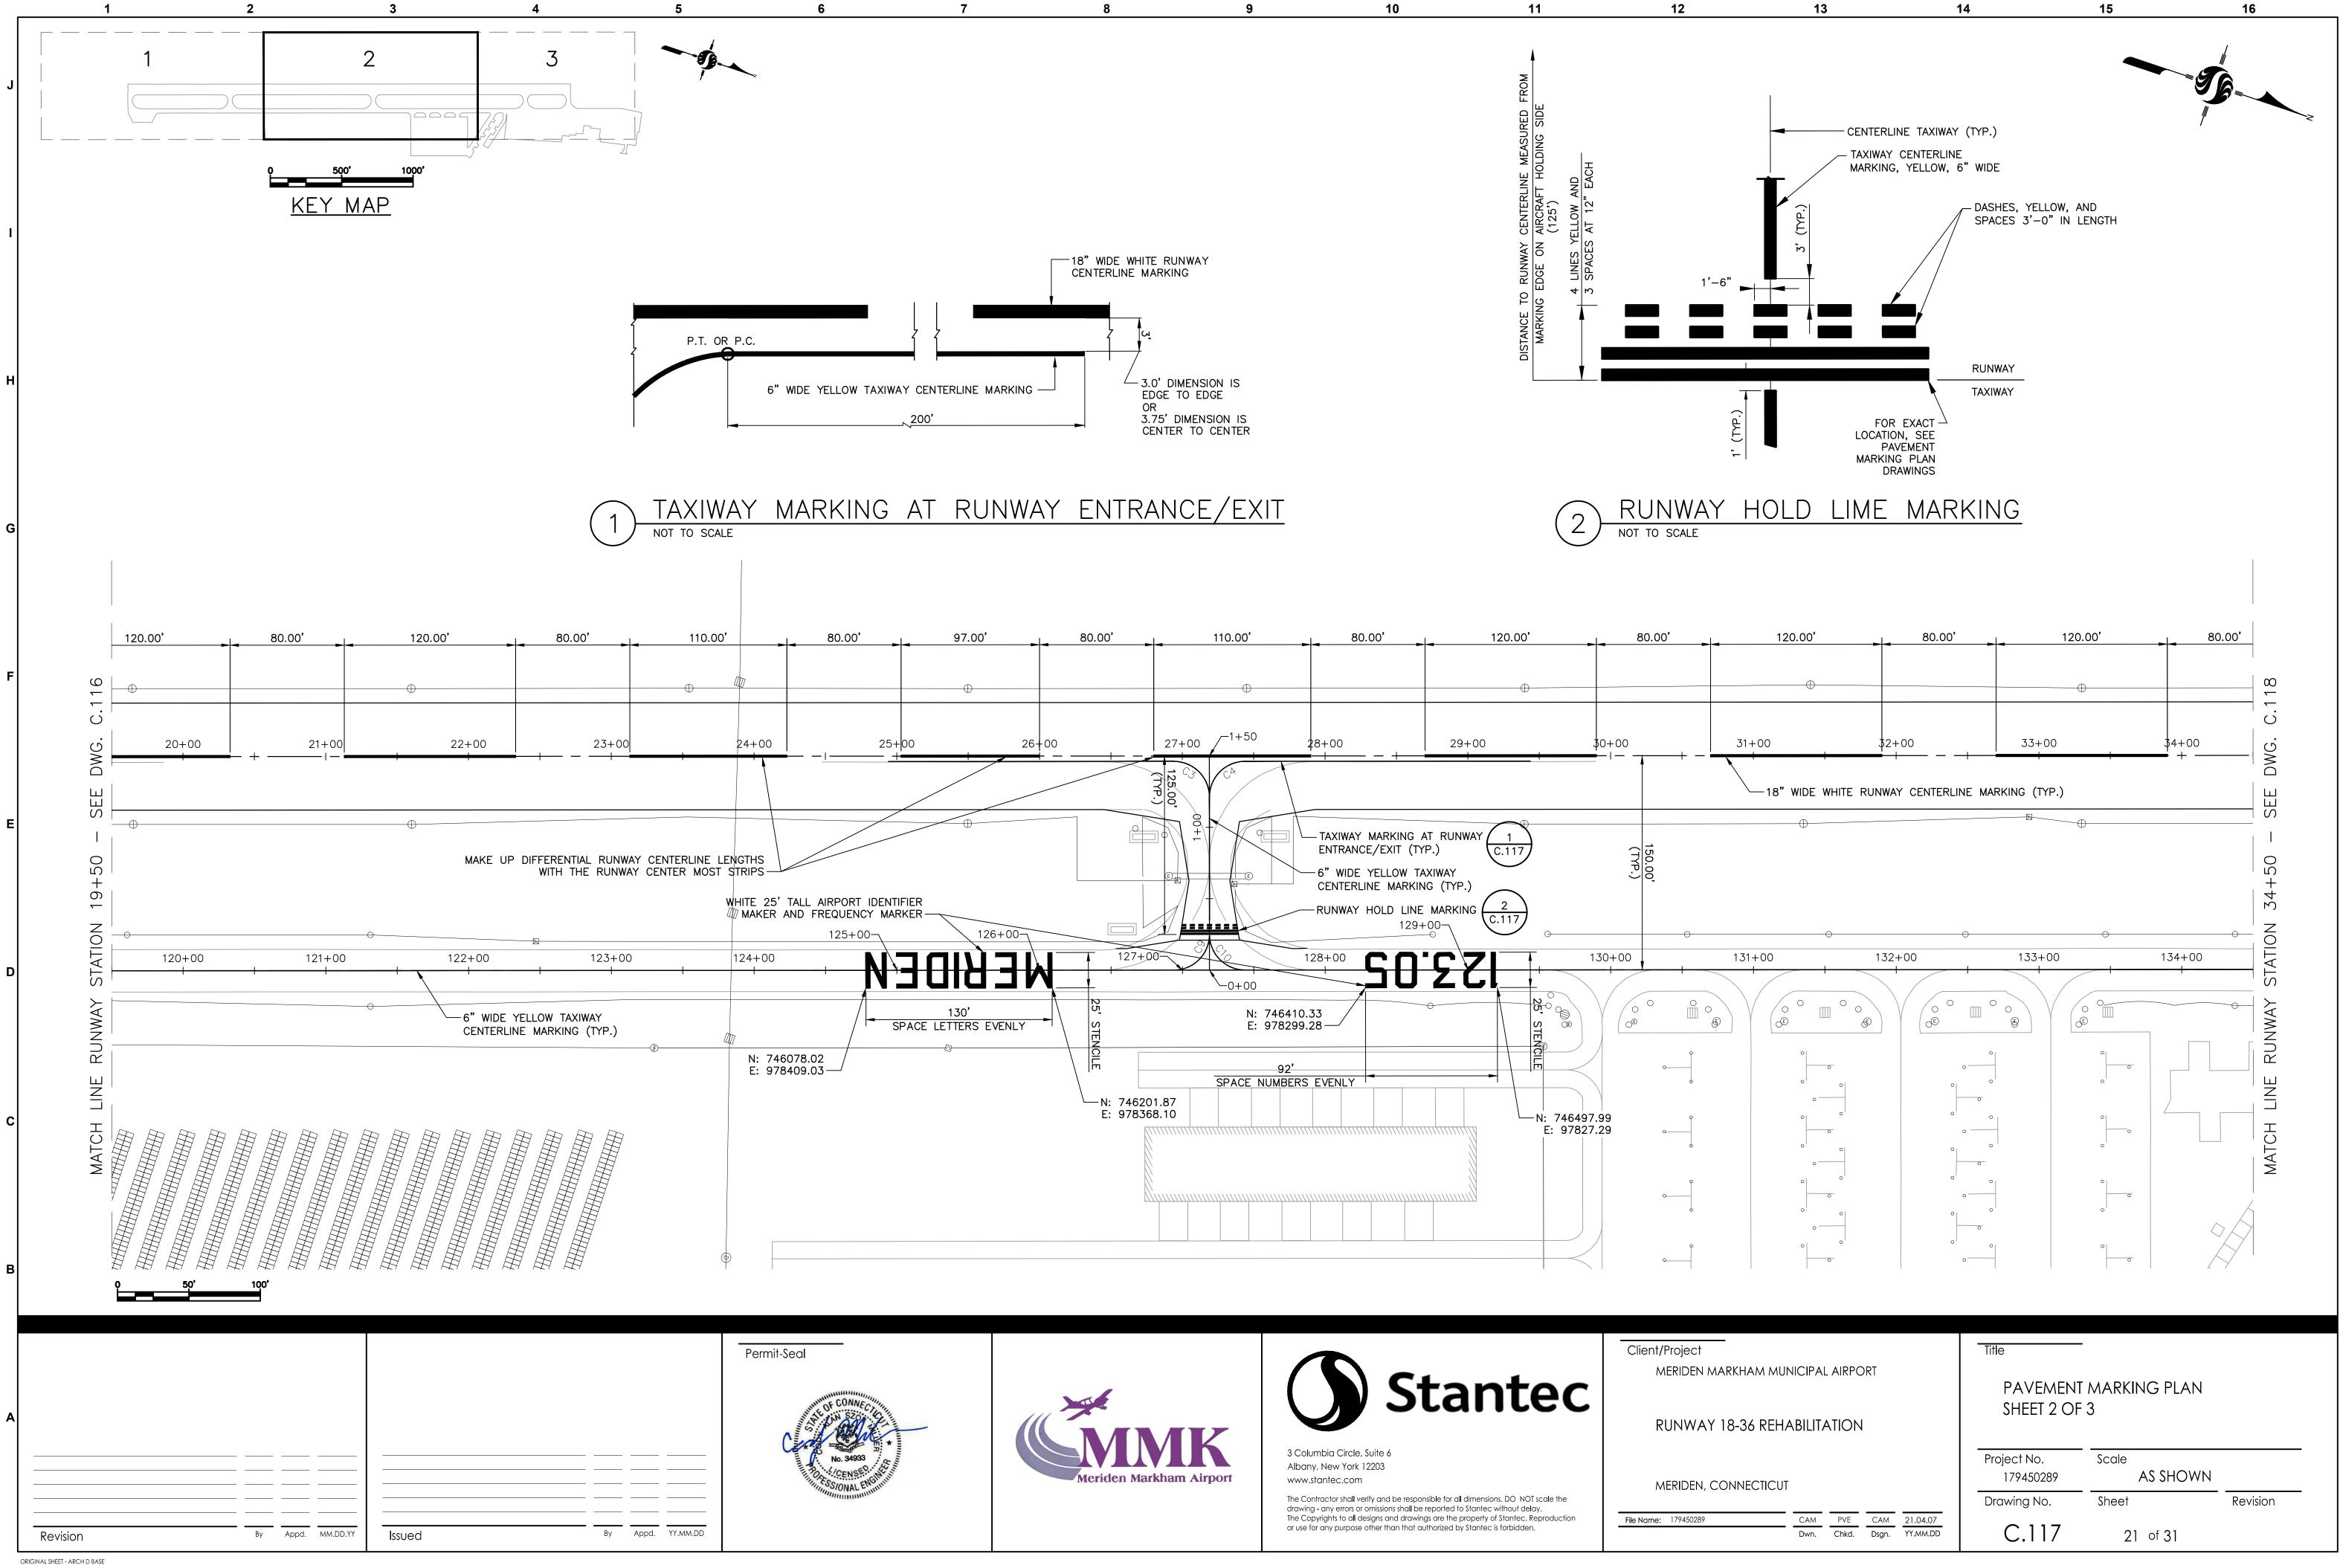





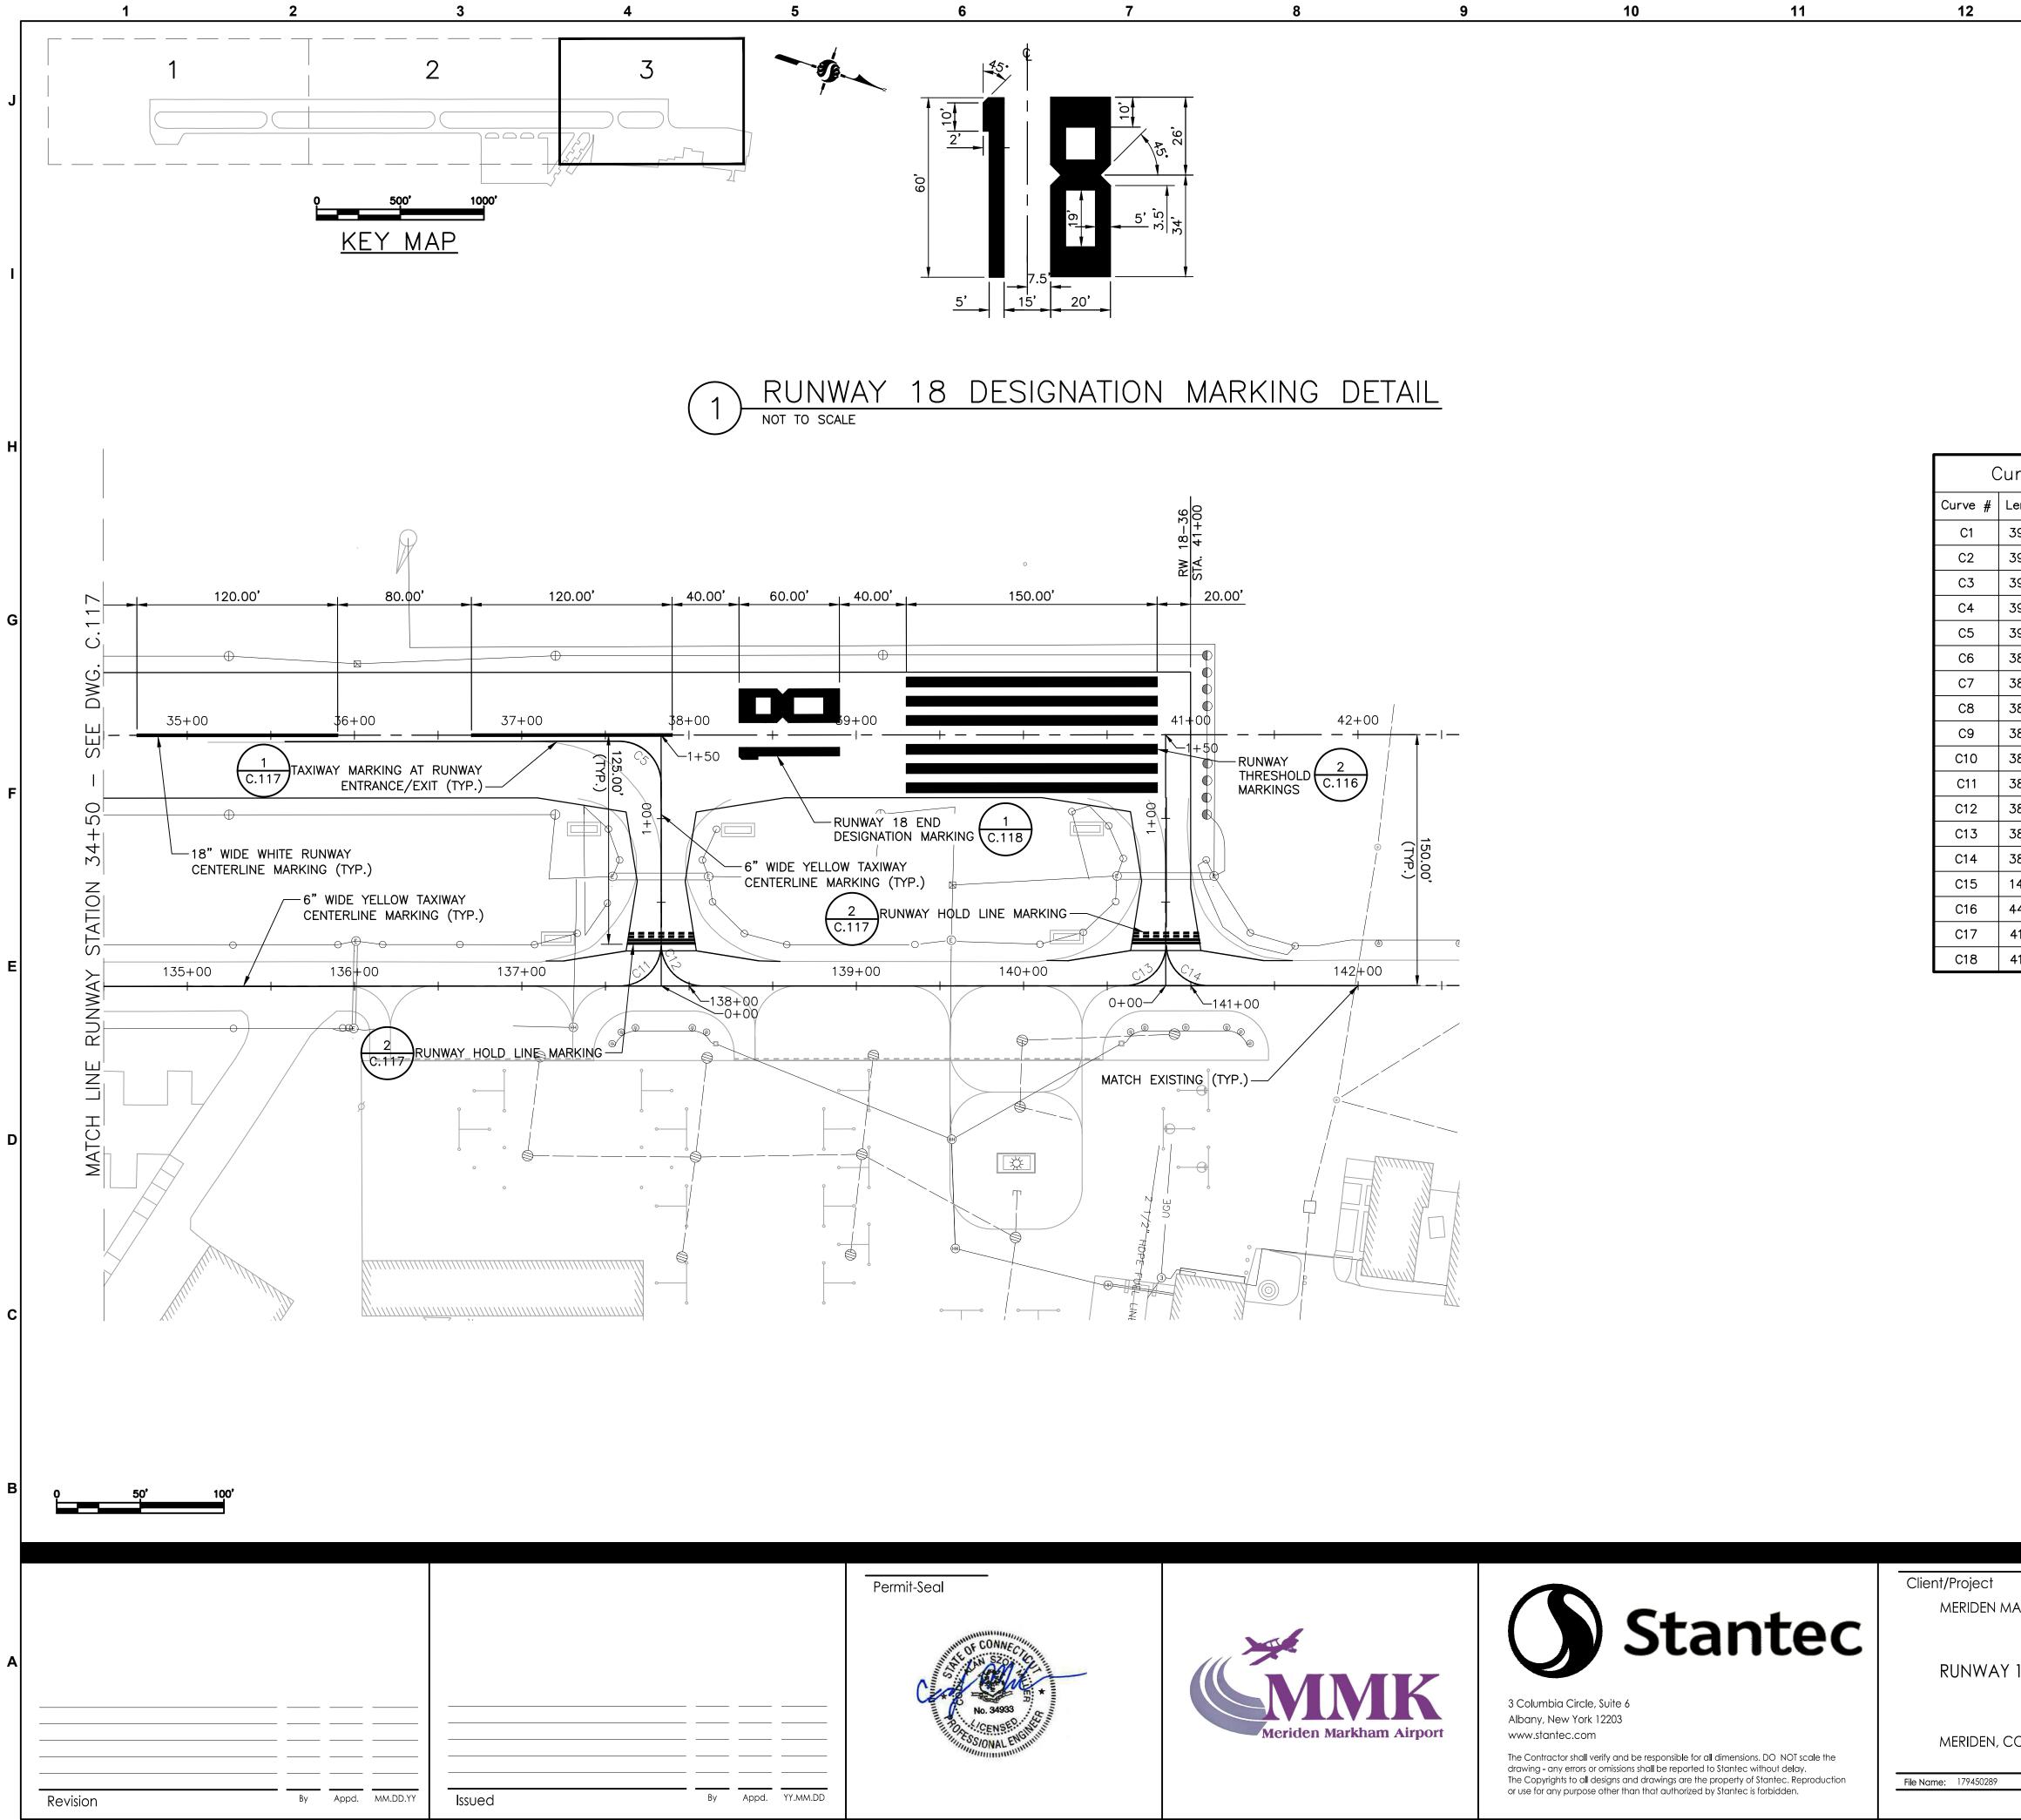


Curve Table						
Curve #	Length	Radius	Delta			
C1	39.27	25.00	90.00			
C2	39.27	25.00	90.00			
C3	39.27	25.00	90.00			
C4	39.27	25.00	90.00			
C5	39.27	25.00	90.00			
C6	38.27	25.00	87.71			
C7	38.27	25.00	87.71			
C8	38.27	25.00	87.71			
C9	38.27	25.00	87.71			
C10	38.27	25.00	87.71			
C11	38.27	25.00	87.71			
C12	38.27	25.00	87.71			
C13	38.27	25.00	87.71			
C14	38.27	25.00	87.71			
C15	14.58	37.50	22.27			
C16	44.33	37.50	67.73			
C17	41.46	37.50	63.34			
C18	41.46	37.50	63.34			

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Title MERIDEN MARKHAM MUNICIPAL AIRPORT PAVEMENT MARKING PLAN SHEET 3 OF 3 RUNWAY 18-36 REHABILITATION Scale Project No. AS SHOWN 179450289 MERIDEN, CONNECTICUT Sheet Drawing No. Revision CAMPVECAM21.04.07Dwn.Chkd.Dsgn.YY.MM.DD C.118 22 of 31

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Α					
	Revision	By Appd. MM.DD.YY	Issued	By Appd.	YY.MM.DD

### ELECTRICAL GENERAL NOTES
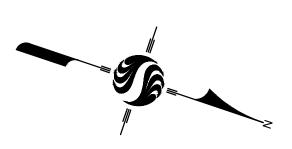
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1. ALL PROPOSED RUNWAY AND TAXIWAY FIXTURES SHALL BE INSTALLED 10' FROM EDGE OF PAVEMENT UNLESS OTHERWISE INDICATED.

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- 2. ALL EXISTING ELEVATED RUNWAY EDGE, THRESHOLD/END AND TAXIWAY EDGE LIGHT FIXTURES AND ISOLATION TRANSFORMERS SHALL BE REMOVED AND STORED IN AN APPROVED MANNER ON AIRPORT PROPERTY, UNLESS OTHERWISE NOTED. CONFIRM INTENT OF REMOVED LIGHT FIXTURES WITH AIRPORT.
- 3. CONTRACTOR SHALL FURNISH AND INSTALL NON-CORROSIVE IDENTIFICATION TAGS FOR ALL LIGHT FIXTURES. EXACT NUMBERING NOMENCLATURE SHALL BE COORDINATED WITH THE AIRPORT AND THE ENGINEER PRIOR TO CONSTRUCTION.
- 4. ALL UNDERGROUND UTILITIES ARE SHOWN IN APPROXIMATE LOCATIONS ONLY. CONTRACTOR SHALL VERIFY THE EXACT LOCATIONS OF ALL DUCTS AND DIRECT BURIED CABLE WITHIN THE PROJECT AREA BY USE OF METAL DETECTORS AND HAND DIGGING PRIOR TO EXCAVATION WITH MECHANICAL EQUIPMENT. ANY DAMAGE TO EXISTING CABLES SHALL BE REPAIRED IMMEDIATELY BY THE CONTRACTOR AT NO EXPENSE TO THE OWNER.
- 5. BOND #6 AWG COUNTERPOISE WIRE TO GROUND ROD AT BEGINNING OF DUCT BANK 5' FROM OPENING. CONTRACTOR SHALL BOND #6 AWG COPPER WIRE TO GROUND ROD UTILIZING EXOTHERMIC WELD (TYPICAL)
- 6. INSTALL PULL WIRE, CAP BOTH ENDS AND INSTALL DUCT MARKERS AT ALL SPARE DUCTS.
- 7. GROUND RODS SHALL BE INSTALLED EVERY 500' ALONG COUNTERPOISE RUNS AND ARE CONSIDERED INCIDENTAL TO ALL RESPECTIVE LINE ITEMS.
- 8. ALL NEW LED RUNWAY AND TAXIWAY LIGHT FIXTURES SHALL BE PROVIDED WITH INTEGRAL HEATER UNIT.
- 9. WHERE POSSIBLE, CONTRACTOR SHALL FURNISH AND INSTALL NEW AIRFIELD LIGHTING CABLES AND CONDUIT IN SAME TRENCH AS REMOVED DIRECT BURIED LIGHTING CABLES.
- 10. CONTRACTOR SHALL REMOVE AND DISPOSE OF EXISTING 600V OBSTRUCTION LIGHT CIRCUIT CONDUCTORS FED FROM SRE BUILDING. CONTRACTOR SHALL FIELD VERIFY EXISTING CONDUCTOR ROUTING IN FIELD. AS-BUILT DRAWINGS INDICATE EXISTING CONDUCTORS ARE ROUTED ALONG NORTHERN END OF RUNWAY 36 AND ALONG WEST SIDE OF RUNWAY 18–36 AND THEN SOUTH TO OBSTRUCTION LIGHT LOCATION BEYOND RUNWAY 18 END. CONTRACTOR SHALL ABANDON OBSTRUCTION CABLES BEYOND RUNWAY 18 END AND PROVIDE CONCRETE CABLE MARKER IN LOCATION WHERE ABANDONED CABLES REMAIN.

12







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RUNWAY

MERIDEN, C

File Name: 50289\_23\_E.001\_


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	ELECTRICAL LEGEND
1BOL	DESCRIPTION
	EXISTING ELEVATED STAKE/BASE MOUNTED RUNWAY EDGE LIGHT. LETTER DENOTES LENS COLOR
	EXISTING ELEVATED STAKE/BASE MOUNTED RUNWAY THRESHOLD/END LIGHT. LETTER DENOTES LENS COLOR
	EXISTING ELEVATED STAKE/BASE MOUNTED TAXIWAY EDGE LIGHT
Ŕ	EXISTING RUNWAY END IDENTIFIER LIGHT
	EXISTING ILLUMINATED AIRFIELD GUIDANCE SIGN
Ē	EXISTING ELECTRICAL JUNCTION STRUCTURE
E)	EXISTING ELECTRICAL SQUARE HANDHOLE
C	EXISTING CONCRETE DUCT/CABLE MARKER
E	EXISTING CONCRETE ENCASED DUCT BANK. SIZES AS INDICATED
Ε	EXISTING DIRECT BURIED AIRFIELD LIGHTING CABLE(S)
Z ———	EXISTING DIRECT BURIED COUNTERPOISE WIRE
•	EXISTING GROUND ROD
∕ w⊕w	PROPOSED ELEVATED STAKE/BASE MOUNTED RUNWAY EDGE LIGHT. LETTER DENOTES LENS COLOR
🖊 G 💽 R	PROPOSED ELEVATED STAKE/BASE MOUNTED RUNWAY THRESHOLD/END LIGHT. LETTER DENOTES LENS COLOR
$\triangleleft$	PROPOSED ELEVATED STAKE/BASE MOUNTED TAXIWAY EDGE LIGHT
	PROPOSED ILLUMINATED AIRFIELD GUIDANCE SIGN AND JUNCTION CAN
Ħ	PROPOSED L-867 ELECTRICAL JUNCTION CAN
/ C	PROPOSED CONCRETE DUCT/CABLE MARKER
E	PROPOSED DIRECT BURIED AIRFIELD LIGHTING CABLE(S)
z ——	PROPOSED DIRECT BURIED #6 AWG BARE COUNTERPOISE WIRE
▼	PROPOSED GROUND ROD
<	TO BE REMOVED, DISPOSED OF, REPLACED OR ABANDONED, UNLESS OTHERWISE NOTED.
11 11 -	UNDERGROUND CABLES BE REMOVED, DISPOSED OF, REPLACED OR ABANDONED, UNLESS OTHERWISE NOTED.
/	EXISTING/PROPOSED CIRCUIT ID. * INDICATES TWO SERIES LIGHTING CABLES. 'TW' – TAXIWAY, 'RW' – RUNWAY

AIRFIELD LIGHTING CIRCUIT	INDEX
RUNWAY 18-36	RW
TAXIWAY	TW
WINDCONE	WND
OBSTRUCTION LIGHT	OBS

ARKHAM MUNICIPA	L AIRPC	ORT			- AL LEGEND AND G	eneral notes	
18-36 REHABILIT	ATION	1					
CONNECTICUT				Project No. 179450289	Scale AS SHOWN	١	
CONNECTICUT				Drawing No.	Sheet	Revision	
01_electrical legend.dwgHAB Dwn.	PVE Chkd.	HAB Dsgn.	21.04.07 YY.MM.DD	E.001	23 of 31		



	7	8	9		10		11	12	
				FIXTURE ANI	D SIGN SCI	HEDULE	FIXTURE /	AND SIGN SCI	HEDULE
	FOR ELECTRICAL LEGEND AND GENE CONTROL CABLES, JUNCTION CANS A		LOCATED	RW20	745339.63	978431.57	SIGN S13	745384.39	978523.74
DING BAY SHA AIRFIELD LIGHT	ALL REMAIN DURING DEMOLITION AND TING CABLES. CONTRACTOR SHALL H JIPMENT AND MATERIALS ARE DAMAGI	) INSTALLATION OF TAXIWA HAND DIG AROUND AREA	Y EDGE NEAR	RW21	745154.45	978492.68	SIGN S14	745357.05	978559.55
	AND SHALL REPLACE DAMAGED EQUI			RW22 RW23	744969.27	978553.79 978614.90	SIGN S15 SIGN S16	745255.24	978566.36 978613.90
AND TAXIWAY	ELEVATED LIGHT FIXTURES SHALL BE	E LOCATED 10' FROM DEI	FINED	RW24	744598.92	978676.01	SIGN S17	744917.96	978747.11
UNTERPOISE W	/IRE SHALL BE FURNISHED AND INST			RW25	744602.05	978685.50	SIGN S18	744691.72	978779.12
_D LIGHTING C	ED AIRFIELD LIGHTING CABLES AND I ABLES ARE RUN IN TRENCH NOT PA COUNTERPOISE SHALL BE FURNISHE	ARALLEL TO DEFINED PAVE	EMENT	RW26	744605.19	978695.00	SIGN S19	744719.06	978743.30
BLES IN SAME	TRENCH.			RW27	744608.32	978704.50	SIGN S20	744648.23	978841.38
SHALL REMOV	ER TAXIWAYS AND CONNECTED SQUAR /E EXISTING AIRFIELD LIGHTING CABLE ND CLEAN OUT EXISTING RACEWAYS	ES AND PRIOR TO INSTAL	LING NEW	RW28	744619.29	978737.73			
	TION OF EXISTING DUCTBANKS AND			RW29 RW30	744622.42	978747.23 978756.72			
				RW30	744628.69	978766.22			
				RW32	744813.87	978705.11			
				RW33	744999.04	978644.00			
				RW34	745184.22	978582.89			
HT AND OF 2) BASE D/END SHEET) STAKE	SHALL REMA	AIN AND BE PROTEC INWAY 36 END (TYP. EXISTING / CAN SH/	MOL	XTURES NG NOTE 2 D SIGN, FOUNDATION DISPOSED OF. RE	EMOVE EXISTI ET) STAKE E LIGHT	NG	AND DISPOS	EVATED RUNWAY ED OF. REMOV WEEN EXISTING	E EXISTING AIR
D/END SHEET) —		<u>- zg/</u> z	RW23 D E ₩ ZD ZD		ZO -	WY RW22	ZO Z	ZO ————————————————————————————————————	
	G G RRW26 G RRW27				/P		1/C L-824C, 5k\ LIGHTING CABLE		
		/ 11+00	12+00	13+00	/ _	14+00		15+00	16+
Lights – Rfield						I	I	PROPOSED 2	'-1/C L-824C
(TYP.) F		-TW <u>111</u>				RUNWAY 1	8–36		D LIGHTING CA
AXIWAY <sup>F</sup> SHEET) ——	RW30G $\bigcirc$ R $\downarrow$ TW109 RW31G $\bigcirc$ R $\bigcirc$ $\bot$ TW109	CZ		<u> </u>	E CZ		- CZ <u> </u>	▼CZ <u> </u>	- CZW
,		B SIGN S19 3	EXISTING ELEVATED	TAXIWAY EDGE LIGH		RW33			RW34
(TYP.) —				LIGHTING CABLES BE	TWEEN				
EMAIN. HTING			EXISTING FIXTURES	(TYP. OF 25 THIS :	SHEET)	PROPOSED	1-1/C #6 AWG	BARE	
(TYP.)—	$A = T      _{+} = -+ -+ -+ T W   06$		1103TW102	TW101			ITERPOISE WIRE (		
(20)		ZO	— Zo — Z:	D ZD	<u></u>	z5	— ZO —	▼ Z⊃	Z2
+	$(\mathbb{B})$ sign s20 $(\mathbb{W})$	111+00 — — I — — — +	<u> </u>	<u>113+00</u>	<u> </u>	114+00	·	115+00 — <del>+</del> –	116 <del>+</del> -
JNIKUL	/114-		C2	cz	cz	CZ	TAXIWAY A	C	Z
SHALL NOTE 2——	TW115		10 1w122 17 1w121		<u>_</u>	∃	w124 3		
	TW115								
				XISTING FAA PAPI AN				-861T(L) STAKE SIWAY EDGE LIGH	
POWER	-TW116			CONCRETE MARKERS TYP.). REFER TO D	SHALL REMA	N	(TYP. OF 40		
REMAIN				111.). KEIEK 10 D		. 2			
NOTE 2									

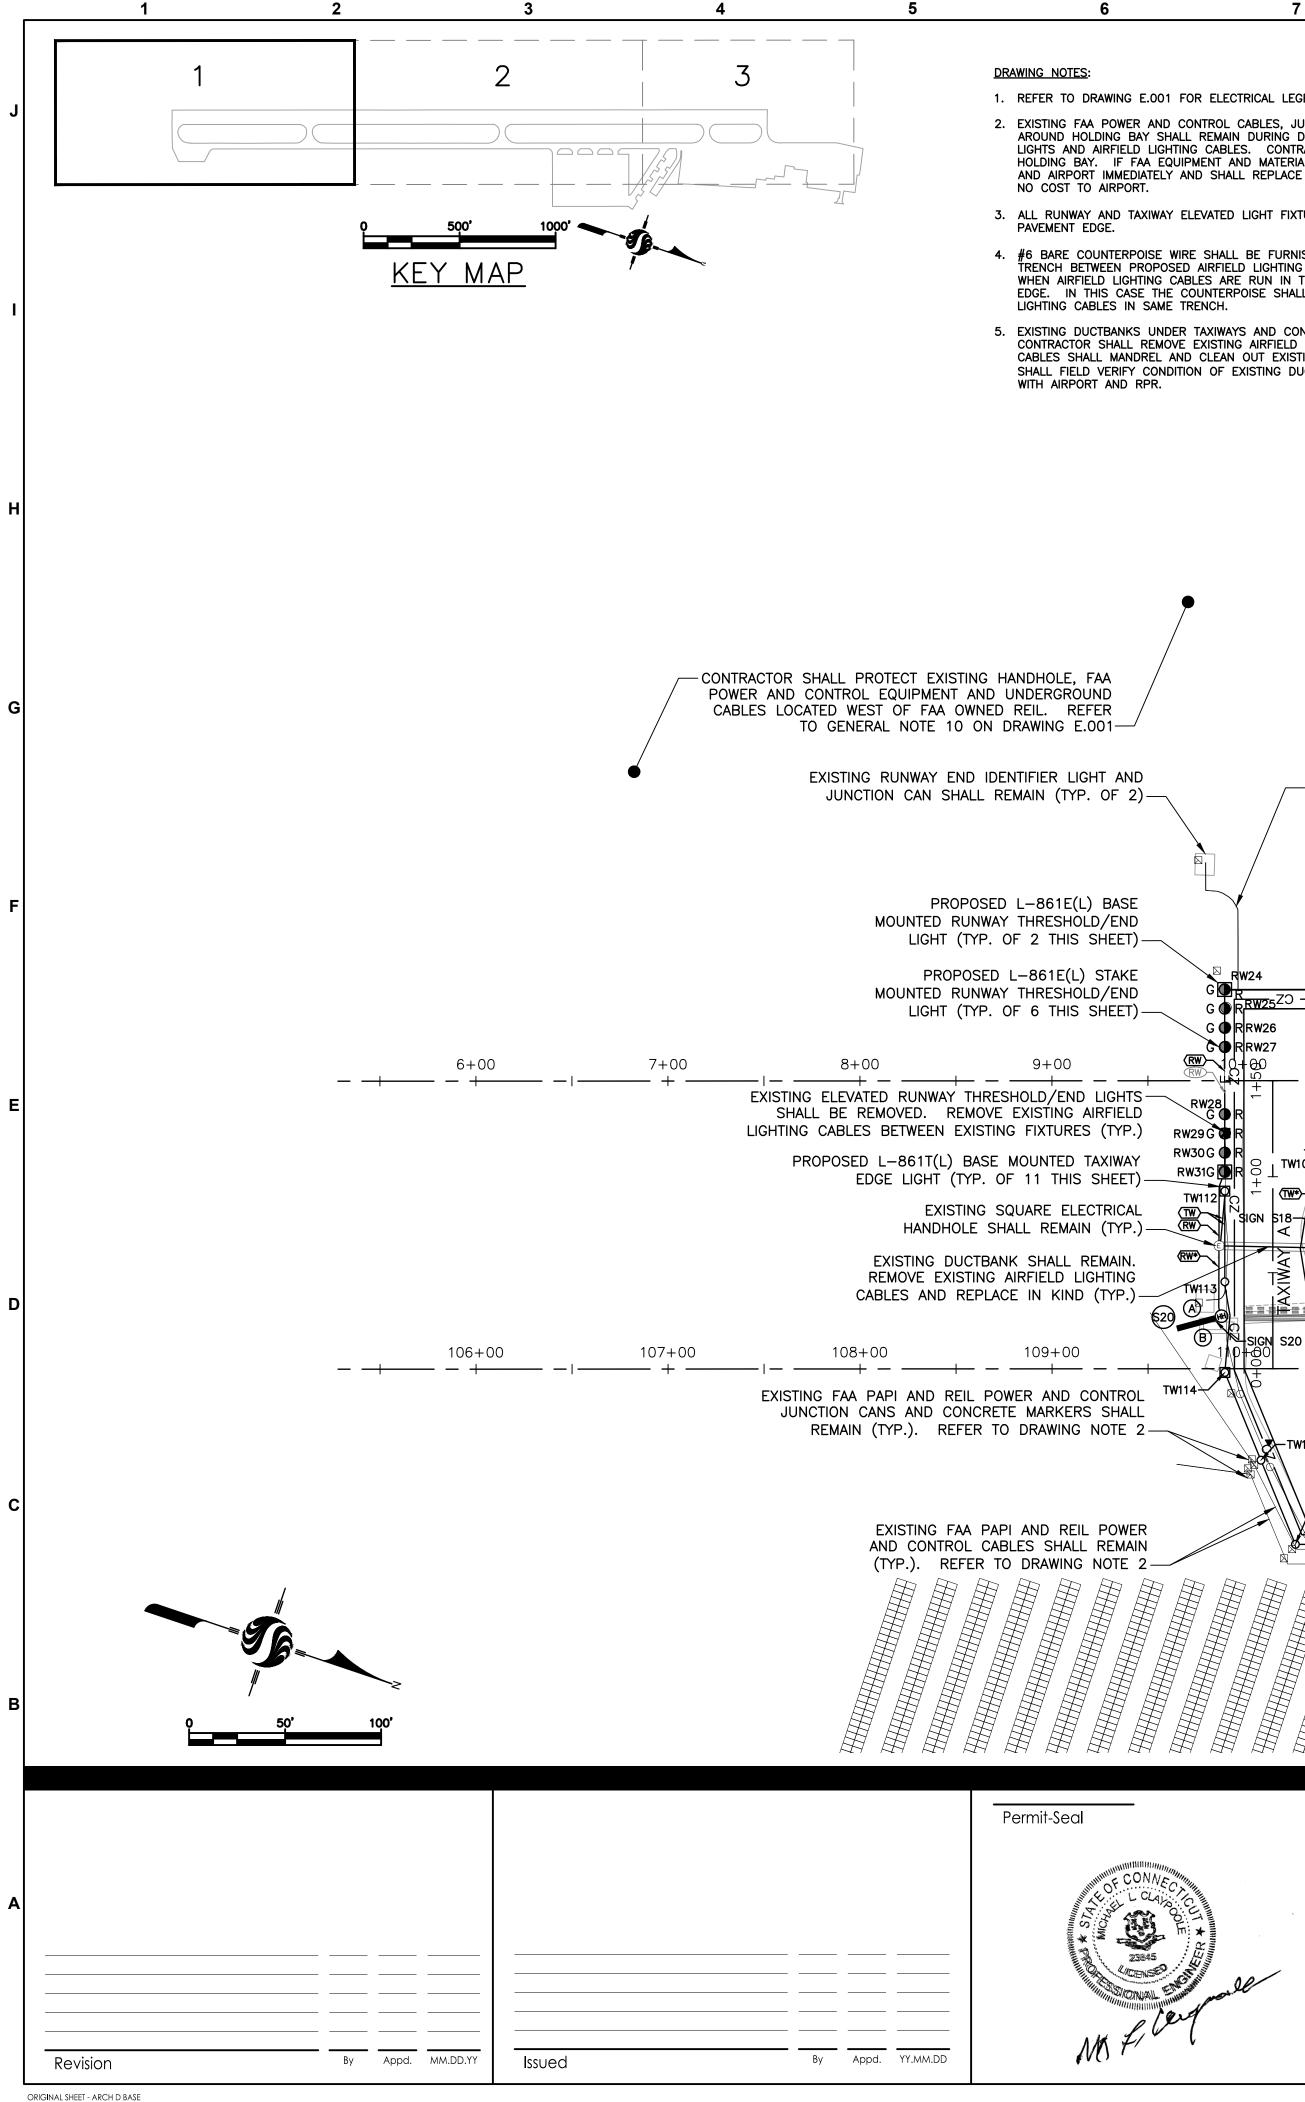



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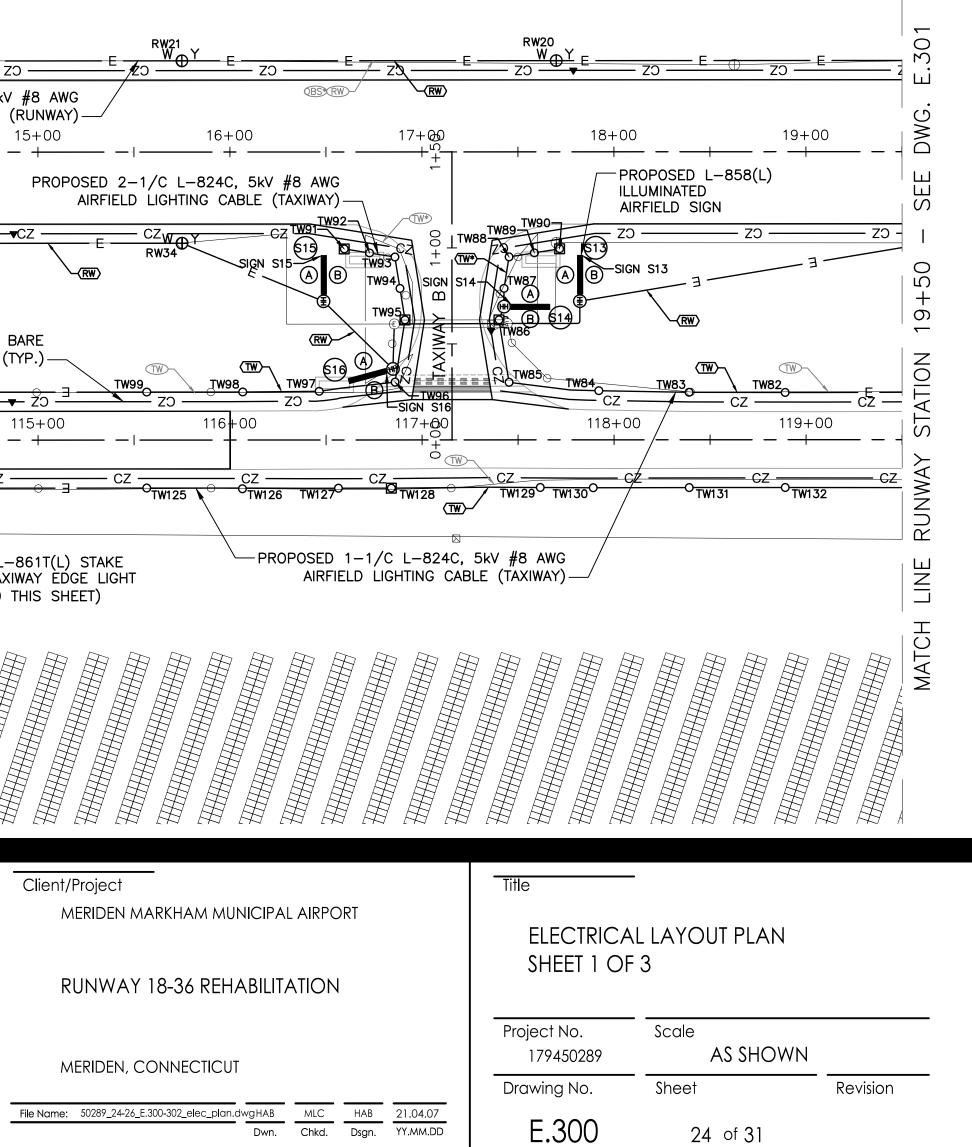
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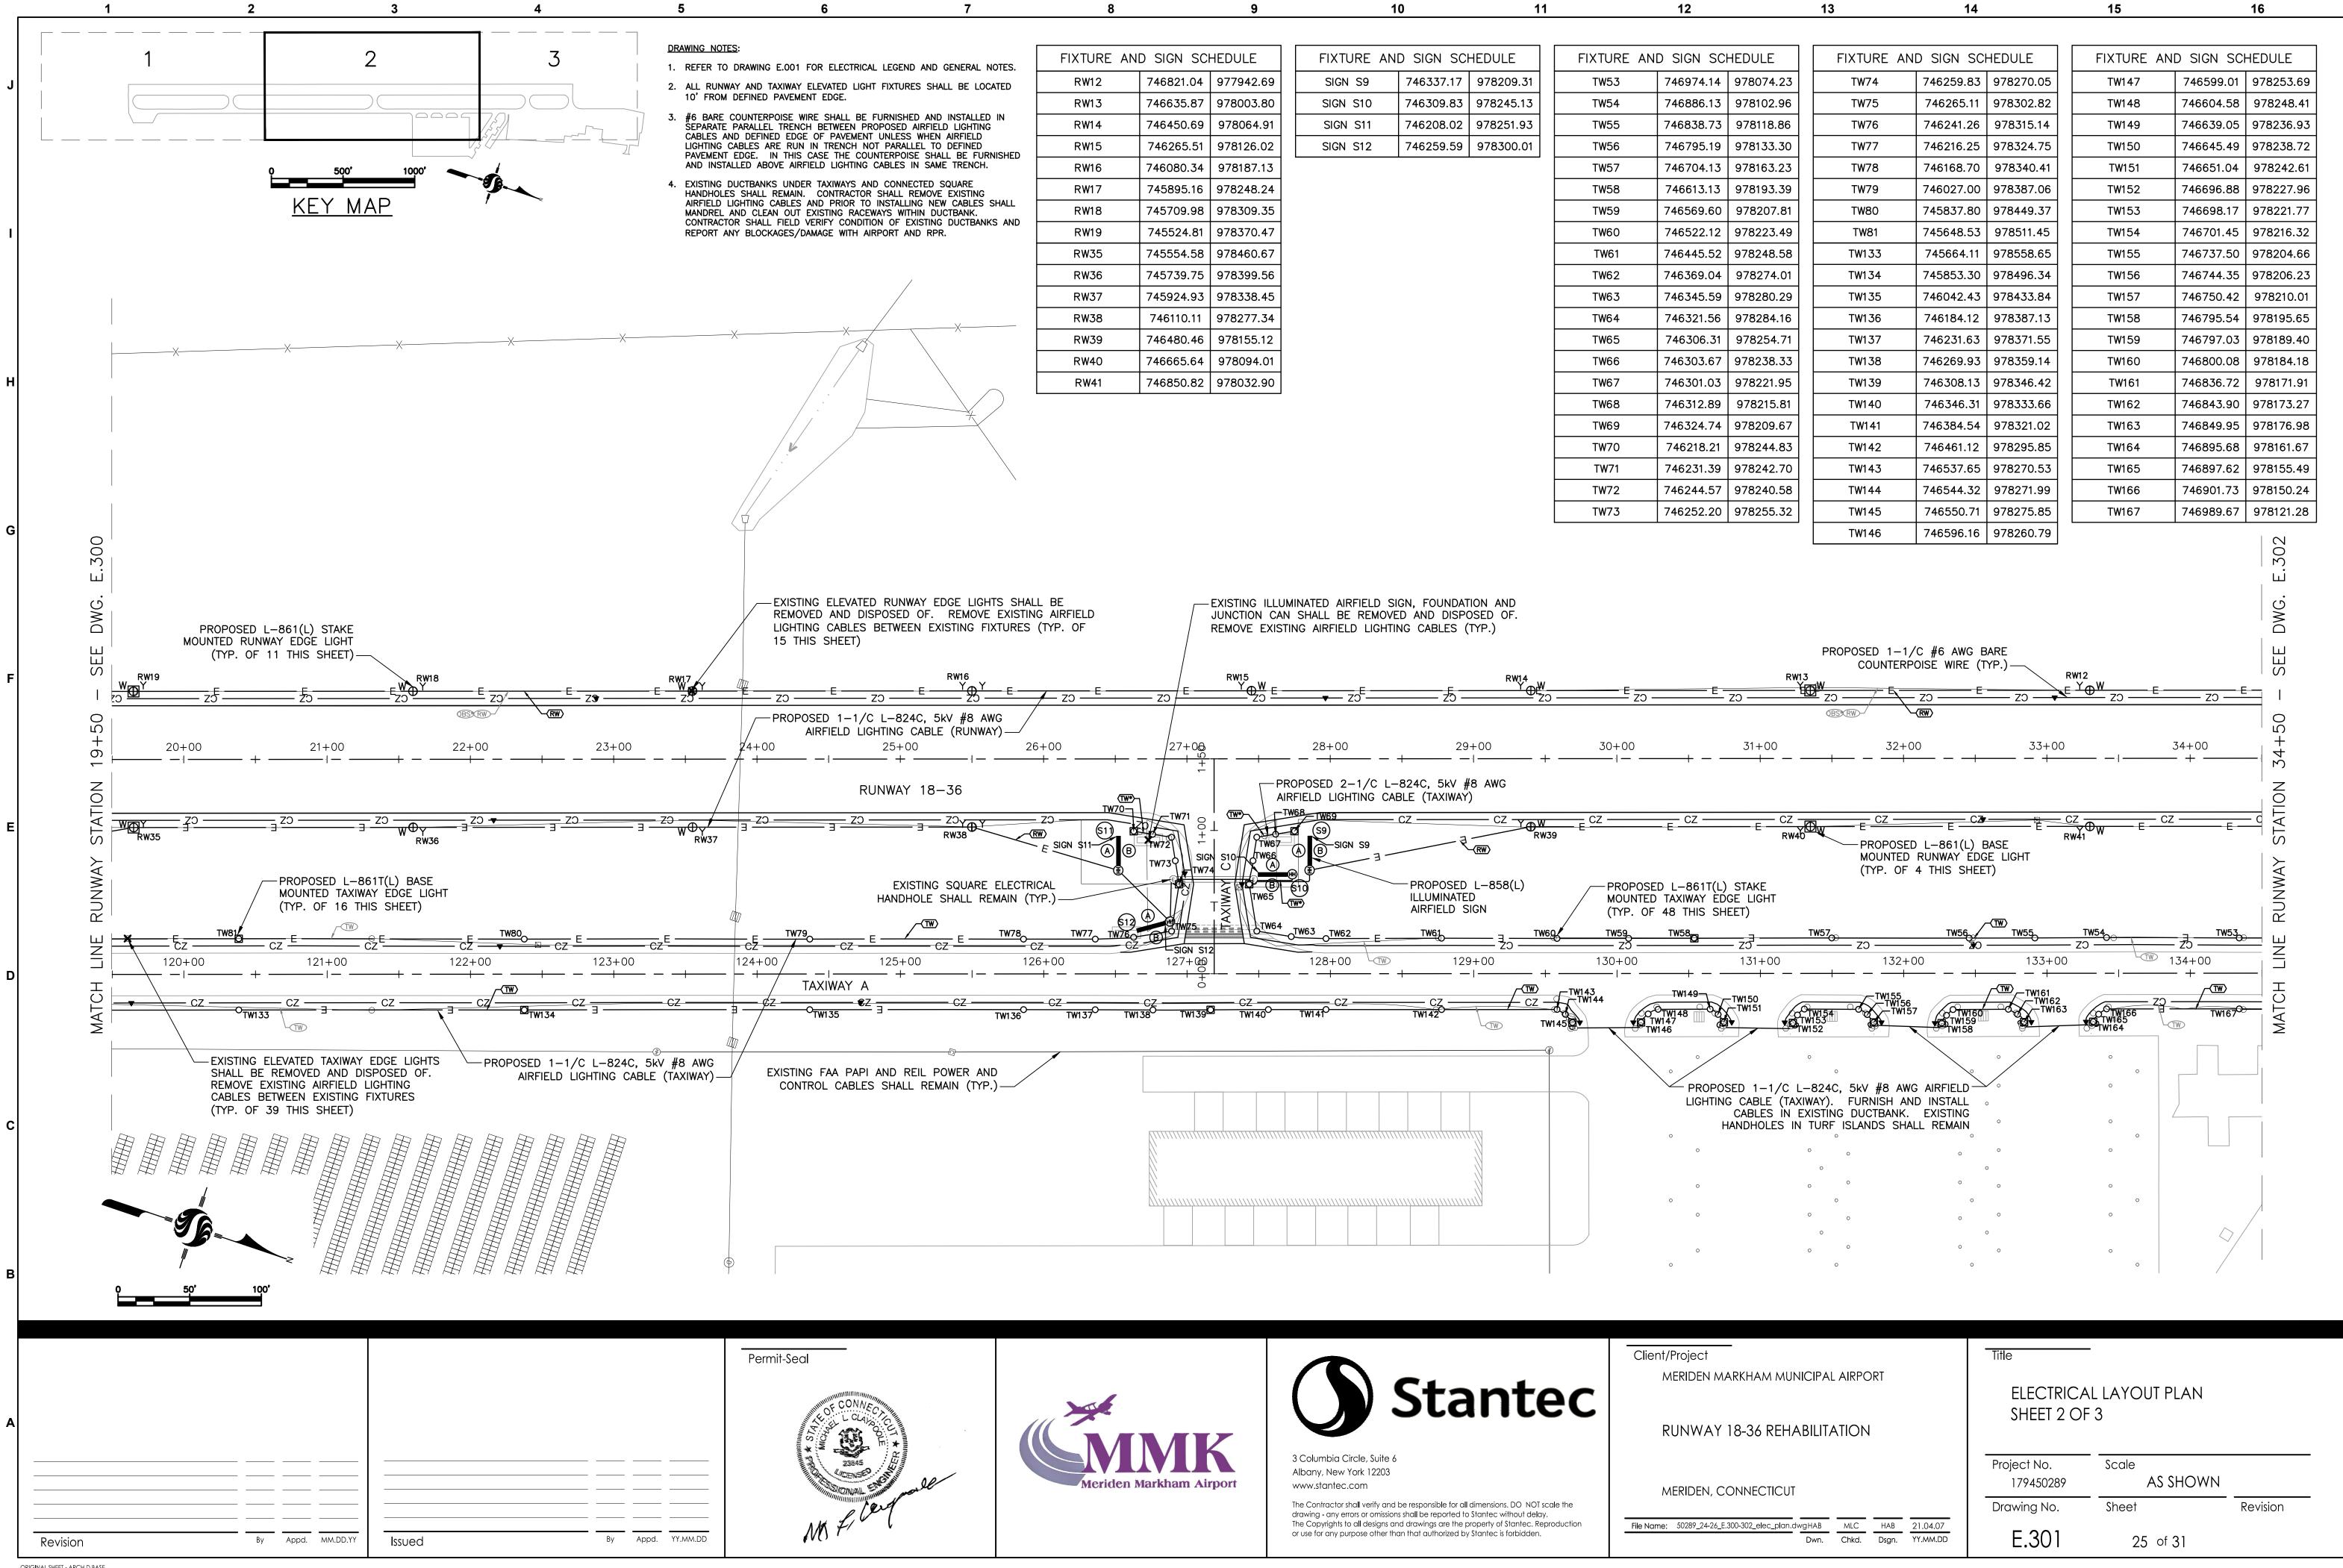
FIXTURE AN	D SIGN SCI	HEDULE
TW82	745506.93	978558.41
TW83	745459.38	978574.00
TW84	745414.47	978587.93
TW85	745368.67	978598.38
TW86	745353.53	978569.14
TW87	745350.89	978552.76
TW88	745348.25	978536.37
TW89	745360.11	978530.23
TW90	745371.96	978524.09
TW91	745265.43	978559.25
TW92	745278.61	978557.13
TW93	745291.79	978555.00
TW94	745299.42	978569.74
TW95	745307.05	978584.48
TW96	745312.27	978616.86
TW97	745276.23	978633.78
TW98	745238.51	978646.59
TW99	745191.03	978662.26
TW100	745052.78	978707.88
TW101	744914.52	978753.50
TW102	744867.04	978769.17
TW103	744822.34	978783.93
TW104	744777.64	978798.68
TW105	744732.38	978813.61
TW106	744703.47	978818.18

FIXTURE AN	D SIGN SCI	HEDULE
TW107	744688.20	978788.70
TW108	744685.57	978772.32
TW109	744682.93	978755.93
TW110	744694.78	978749.80
TW111	744706.64	978743.66
TW112	744631.82	978775.72
TW113	744646.63	978820.57
TW114	744661.43	978865.43
TW115	744693.52	978902.95
TW116	744724.31	978938.96
TW117	744770.56	978923.70
TW118	744816.81	978908.43
TW119	744863.06	978893.17
TW120	744867.81	978860.95
TW121	744872.57	978828.73
TW122	744882.71	978816.66
TW123	744930.19	978800.99
TW124	745068.45	978755.36
TW125	745206.70	978709.74
TW126	745254.67	978694.31
TW127	745301.54	978678.60
TW128	745327.71	978669.93
TW129	745401.27	978645.33
TW130	745427.50	978636.82
TW131	745474.96	978621.09
TW132	745522.45	978605.45


S SHALL BE REMOVED AIRFIELD LIGHTING YP. OF 7 THIS SHEET)



24 of 31



6	7	8		9		10	11		12
								<b>[</b>	
R ELECTRICAL LEGEN	ND AND GENERAL NOTES.	FIXTURE AN	ND SIGN SC	HEDULE	FIXTURE A	ND SIGN SC	HEDULE	FIXTURE A	ND SIGN SO
	RES SHALL BE LOCATED	RW12	746821.04	977942.69	SIGN S9	746337.17	978209.31	TW53	746974.14
EDGE. SHALL BE FURNISH	IED AND INSTALLED IN	RW13	746635.87	978003.80	SIGN S10	746309.83	978245.13	TW54	746886.13
BETWEEN PROPOSED OF PAVEMENT UNLES	AIRFIELD LIGHTING S WHEN AIRFIELD	RW14	746450.69	978064.91	SIGN S11	746208.02	978251.93	TW55	746838.73
	ISE SHALL BE FURNISHED	RW15	746265.51	978126.02	SIGN S12	746259.59	978300.01	TW56	746795.19
D LIGHTING CABLES		RW16	746080.34	978187.13				TW57	746704.13
CONTRACTOR SHALL	REMOVE EXISTING LING NEW CABLES SHALL	RW17	745895.16	978248.24				TW58	746613.13
ISTING RACEWAYS WI		RW18	745709.98	978309.35				TW59	746569.60
AGE WITH AIRPORT A	AND RPR.	RW19	745524.81	978370.47				TW60	746522.12
		RW35	745554.58	978460.67				TW61	746445.52
/	/	RW36	745739.75	978399.56				TW62	746369.04
		RW37	745924.93	978338.45				TW63	746345.59
X/	X	RW38	746110.11	978277.34				TW64	746321.56
(A)		RW39	746480.46	978155.12				TW65	746306.31
		RW40	746665.64	978094.01				TW66	746303.67
		RW41	746850.82	978032.90				TW67	746301.03
								TW68	746312.89
								TW69	746324.74
								TW70 TW71	746218.21
								TW71	746231.39
								TW72	746252.20
SHEET)	RW16 F YoY F			RW15	F	Б.,			F
ZO	24C, 5kV #8 AWG /	/─ zɔ ─ ⊑	ZO / E	Zo	zɔ <sup>t</sup>	zo -	CZ	Z	) E
RFIELD LIGHTING	CABLE (RUNWAY) —								
25+) 	00 26	S+00 + − − +	$-\frac{27+00}{1+1}$	·	28+00	- 29	9+00 -	30+00	+ ·
RUNWA	Y 18-36	(T₩* TW70—			PROPOSED 2-1/C L				
ZD					TW68 TW69 Ø (S9)	- CZ ———		<u> </u>	<u>— е</u> СZ —
		E SIGN S11 A B			B SIGN S9	Ę		2	
	ISTING SQUARE ELECTRI HOLE SHALL REMAIN (T					PROPOSED		PROPO	SED L—861T(L ED TAXIWAY EI
		612				AIRFIELD S	SIGN		OF 48 THIS S
<u> </u>	<u> </u>	TW77_TW76			TW63TW62E=	TW61		<u> </u>	TW58
125+		6+00	SIGN S1		128+00	12	9+00	130+00	
_  + XIWAY A		++-	+ + 0			+			
₩135 €Z	<u> </u>	- CZ	- <u>CZ</u>	CZ	CZ	CZ		-TW143 - TW144	
	10130	10137 10		10140		11112	TW TW		TW147 W147 W146
	<u>a</u>								0
	REIL POWER AND							Ň	○
OL CABLES SHAL	L REMAIN (TYP.)—								
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			Vuunuuu						0
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6 7 8 9		10	1	1	12	
E.001 FOR ELECTRICAL LEGEND AND GENERAL NOTES.	FIXTURE AN	ID SIGN SCI	HEDULE	FIXTURE AN	D SIGN SCI	HEDULE
REMOVE AND DISPOSE OF EXISTING AIRFIELD LIGHTING CABLES (RUNWAY AND TAXIWAY)	RW01	747591.52	977788.46	SIGN S1	747556.85	977871.94
ORS (WINDCONE AND OBSTRUCTION LIGHTS) IN EXISTING RACEWAY BETWEEN SRE ING HANDHOLE IN TURF. PROVIDE CONDUCTORS AS INDICATED. CONTRACTOR SHALL NG AND CIRCUITRY OF EXISTING OBSTRUCTION LIGHTS CIRCUIT. REFER TO GENERAL	RW02	747588.39	977778.97	SIGN S2	747606.30	977817.28
NG E.001.	RW03	747585.26		SIGN S3	747505.26	977823.83
AXIWAY ELEVATED LIGHT FIXTURES SHALL BE LOCATED 10' FROM DEFINED PAVEMENT	RW04	747582.12	977759.97	SIGN S4	747452.67	977911.14
OISE WIRE SHALL BE FURNISHED AND INSTALLED IN SEPARATE PARALLEL TRENCH AIRFIELD LIGHTING CABLES AND DEFINED EDGE OF PAVEMENT UNLESS WHEN AIRFIELD	RW05	747571.15	977726.74	SIGN S5	747347.99	977875.73
RE RUN IN TRENCH NOT PARALLEL TO DEFINED PAVEMENT EDGE. IN THIS CASE THE L BE FURNISHED AND INSTALLED ABOVE AIRFIELD LIGHTING CABLES IN SAME TRENCH.	RW06 RW07	747568.02	977717.24	SIGN S6 SIGN S7	747320.65 747218.84	977911.55 977918.36
S UNDER TAXIWAYS AND CONNECTED SQUARE HANDHOLES SHALL REMAIN. CONTRACTOR TING AIRFIELD LIGHTING CABLES AND PRIOR TO INSTALLING NEW CABLES SHALL	RW07	747561.75	977698.25	SIGN S7	747270.42	
N OUT EXISTING RACEWAYS WITHIN DUCTBANK. CONTRACTOR SHALL FIELD VERIFY ING DUCTBANKS AND REPORT ANY BLOCKAGES/DAMAGE WITH AIRPORT AND RPR.	RW09	747376.58	977759.36		/ 1/2/0.12	
G AIRFIELD LIGHTING CABLE (TAXIWAY) FROM FIXTURE ISOLATION TRANSFORMER.	RW10	747191.40	977820.47			
LL NEW 1/C L—824C, 5kV, #8 AWG AIRFIELD LIGHTING CABLE (TAXIWAY) TO EXISTING RMER FROM PROPOSED ELEVATED TAXIWAY EDGE LIGHT. UTILIZE L—823 PRIMARY CABLE OR KIT FOR PRIMARY CABLE SPLICES AND CONNECTION AT ISOLATION TRANSFORMER.	RW11	747006.22	977881.58			
OR KIT FOR PRIMART CABLE SPLICES AND CONNECTION AT ISOLATION TRANSFORMER.	RW42	747035.99	977971.79			
	RW43	747406.35	977849.57			
XXX						
SCONNECT						
UCTORS AND		UMINATED AIF	FIELD SIGN, I	FOUNDATION AND JU	NCTION	
IRCUITRY				ED OF. REMOVE EX THIS SHEET)	ISTING	
		L-861SE(L) E	1	1 11		
LEVATED RUNWAY EDGE LIGHTS SHALL BE REMOVED		/END LIGHT (				
TWEEN EXISTING FIXTURES (TYP. OF 6 THIS SHEET)		861SE(L) S				
PROPOSED 1-1/C #6 AWG BARE	THRESHOLD,	/END LIGHT (`	IYP. OF 2 TH	IIS SHEET)		
COUNTERPOISE WIRE (TYP.)		EVATED RUNW	 AY THRESHOL	D/END LIGHTS		
$\frac{1}{2} + \frac{1}{2} + \frac{1}$	SHALL BE R	EMOVED. RE	MOVE EXISTIN	G AIRFIELD IXTURES (TYP.)		
39+00 40+00 Q 41+00 41+00	42+00		43+00	44+00		45+00
- + - + - + - + - + - + - + - + - + - +		<u> </u>	- +	— I — (   — — —		
MOUNTED RUNWAY EDGE LIGHT (TYP. OF 5 THIS SHEET)				ITS SHALL BE REMO	VED	
				(TYP. OF 24 THIS SH	HEET)	
(55) RW43Y $(1)$ $(55)$ RW43Y $(1)$ $(53)$						
	ļ					
		RE ELECTRICAL	HANDHOLE S	SHALL REMAIN (TYP.)		
TW35 SIGN S4 B TW34 TW35 TW34 TW33 TW3 S1 A TW33 TW34 S1 A TW33 TW34 S1 A TW33 TW3 S1 A TW3 S1 A TY	W21					
CZ - CZ - CZ - SIGN SI - TW32					· · · · · · · · · · · · · · · · · · ·	
- + - + - + - + - + - + - + - + - + - +		<u> </u>	43+00 - /	144+00 		145+00
PROPOSED L-861T(L) STAKE				LIGHT SHALL REMA	N.	
MOUNTED TAXIWAY EDGE LIGHT   (TYP. OF 23 THIS SHEET)	X	REFER IU	DRAWING NO	DIE 6		
		OSED_L-8611				
EXISTING TAXIWAY		OF 12 THIS				
DISCONNECT EXISTING AIRFIELD CABLES		<u> </u>				
L-824C, 5kV #8 FROM TURF ISLAND TAXIWAY EDGE						
Y, 2-WINDCONE) $+$ $\downarrow$		N. N				
BANK FROM SRE	G C	Aunun	HHHA	- 0 0	00	
DRAWING NOTE 2 $$ SRE BUILDING $$	T DR 3		3			
WITH REGULATORS			3			
	B (Alumn)		3			
	7					
	1					
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			V_			NI

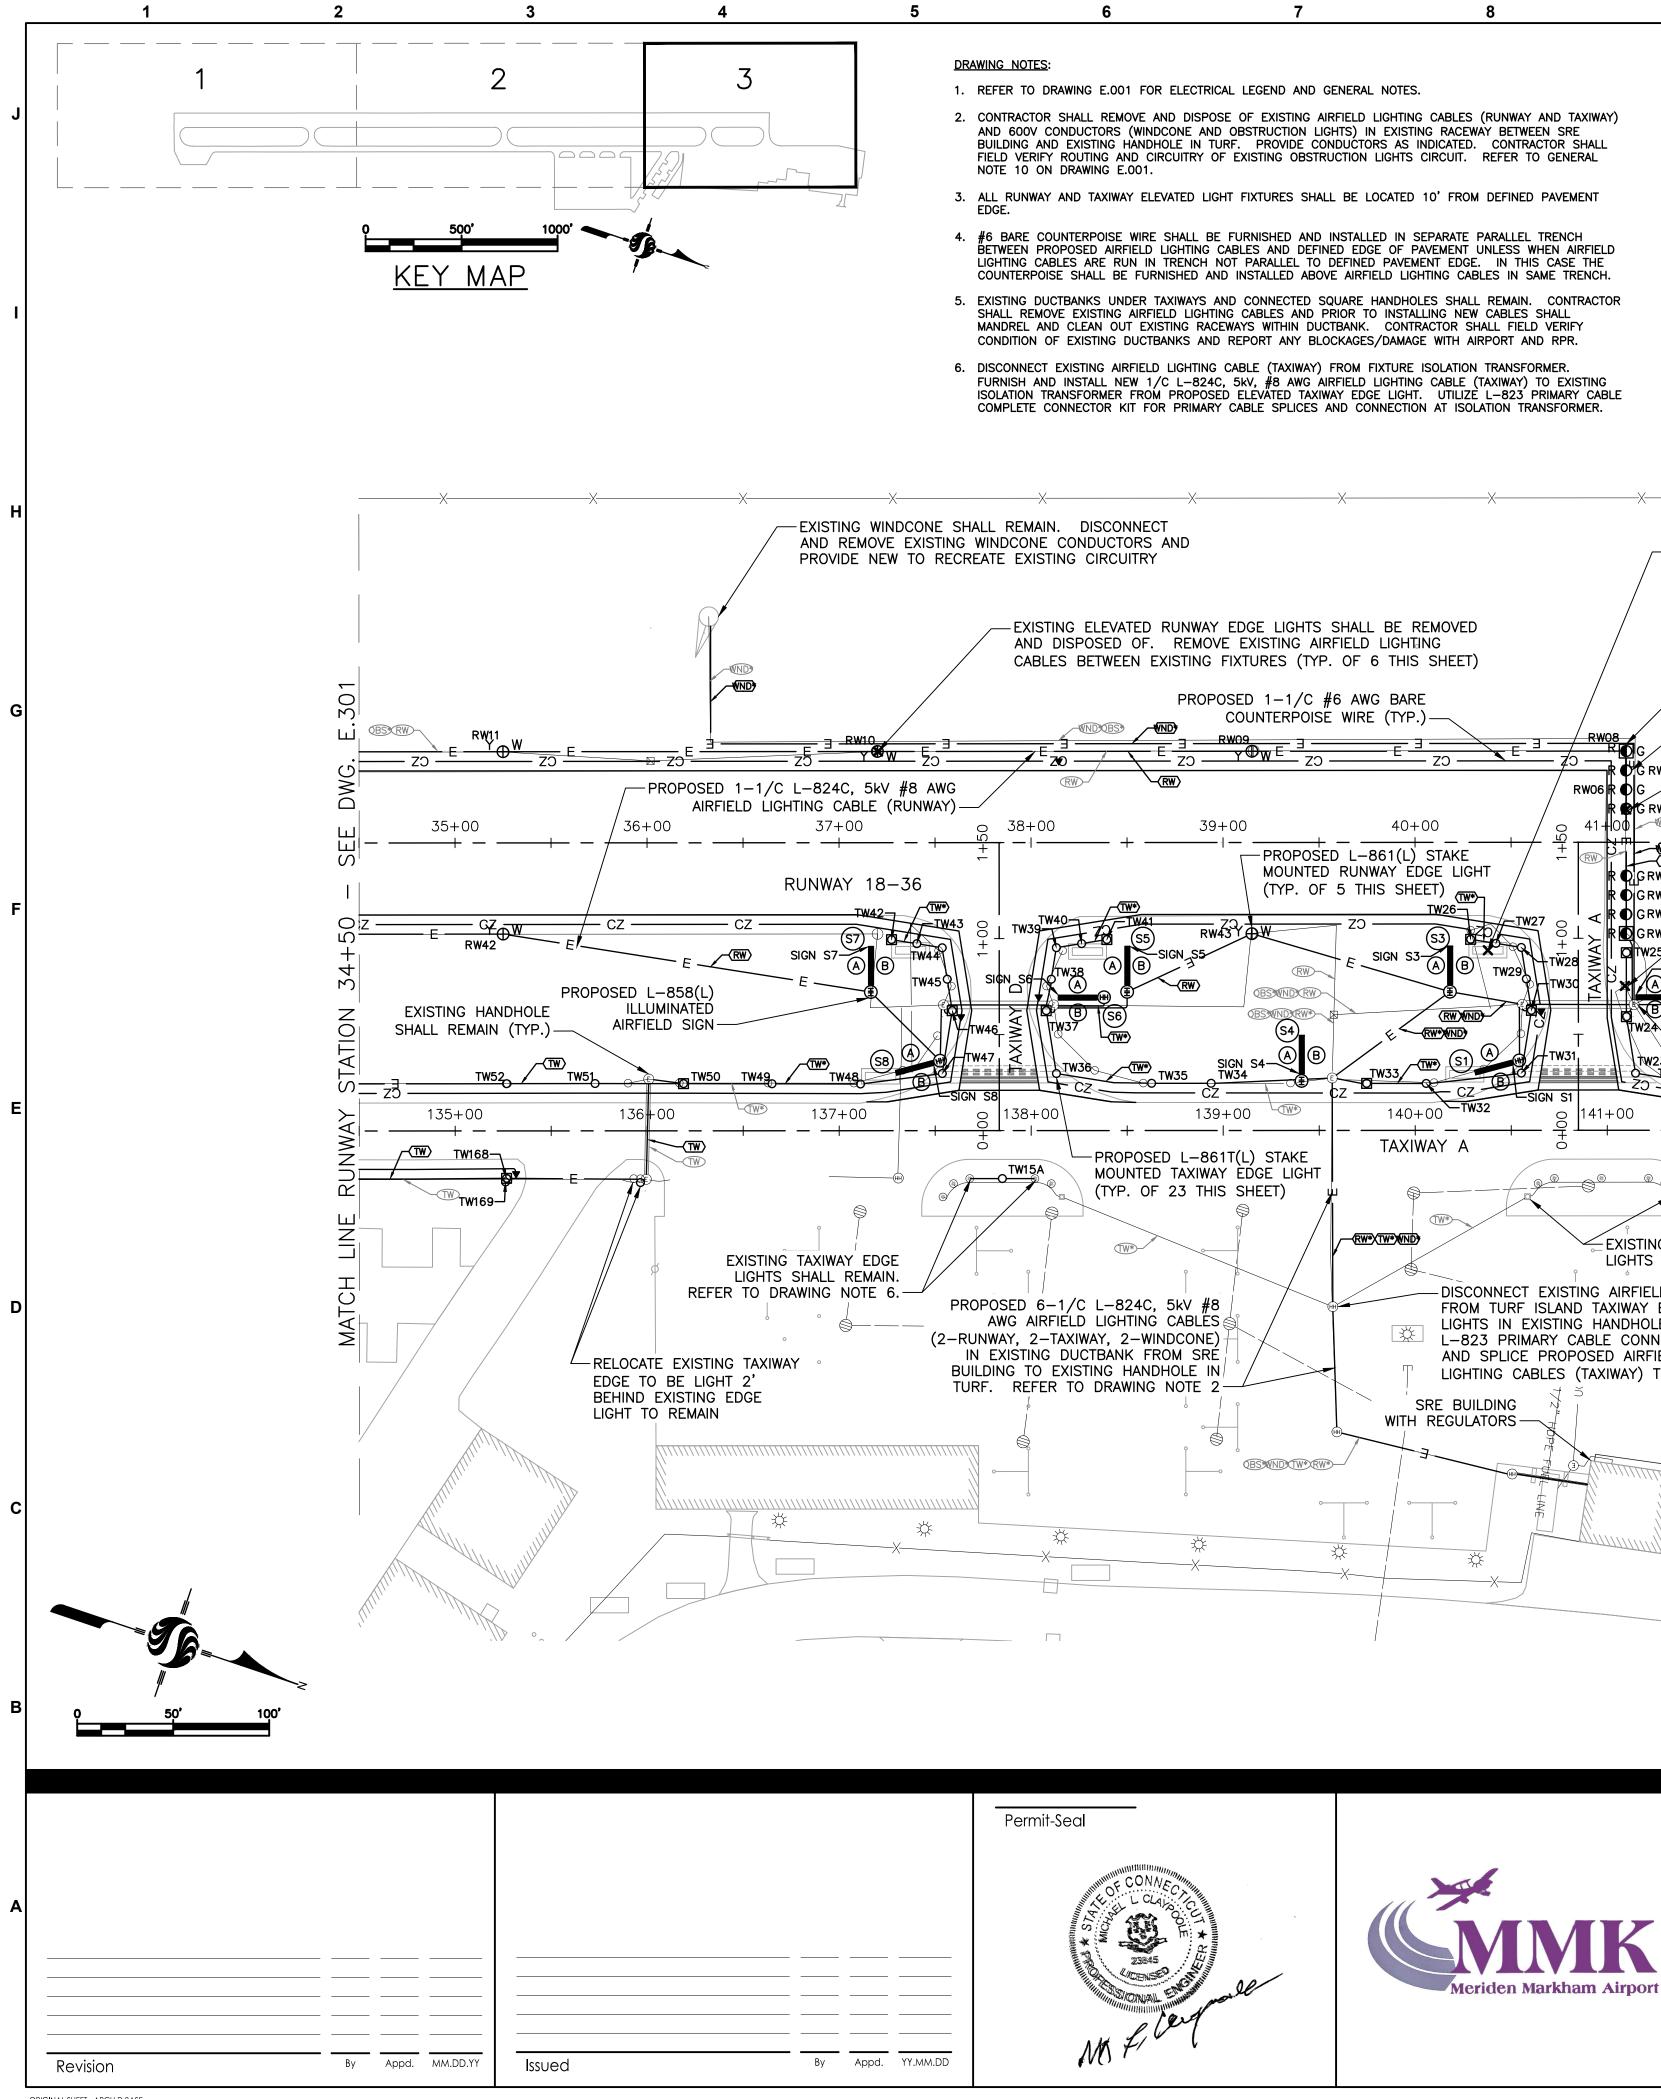

3 Columbia Circle, Suite 6 Albany, New York 12203 www.stantec.com

The Contractor shall verify and be responsible for all dimensions. DO NOT scale the drawing - any errors or omissions shall be reported to Stantec without delay. The Copyrights to all designs and drawings are the property of Stantec. Reproduction or use for any purpose other than that authorized by Stantec is forbidden.

Client/Project MERIDEN M

RUNWAY

MERIDEN, C

File Name: 50289\_24-26\_E

13


14


15

FIXTURE ANI	D SIGN SCI	HEDULE
TW15A	747322.80	978011.39
TW21	747663.91	977846.17
TW22	747648.31	977851.37
TW23	747618.83	977856.12
TW24	747605.11	977829.60
TW25	747594.66	977797.96
TW26	747515.46	977816.72
TW27	747528.65	977814.63
TW28	747541.83	977812.51
TW29	747549.46	977827.24
TW30	747557.09	977841.98
TW31	747562.36	977874.64
TW32	747516.94	977895.28
TW33	747487.50	977904.95
TW34	747410.56	977930.24
TW35	747381.11	977939.92
TW36	747332.41	977950.64

FIXTURE AND SIGN SCHEDULE				
TW37	747317.15	977921.17		
TW38	747314.51	977904.78		
TW39	747311.87	977888.40		
TW40	747323.72	977882.26		
TW41	747335.56	977876.09		
TW42	747229.03	977911.25		
TW43	747242.21	977909.12		
TW44	747255.41	977907.03		
TW45	747263.02	977921.74		
TW46	747270.65	977936.47		
TW47	747275.93	977969.24		
TW48	747237.20	977987.72		
TW49	747193.39	978002.04		
TW50	747149.59	978016.37		
TW51	747105.81	978030.73		
TW52	747062.06	978045.22		
TW168	747077.51	978092.04		
TW169	747077.61	978094.03		




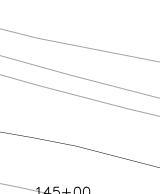

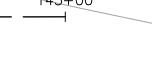





	Title	-	
ARKHAM MUNICIPAL AIRPORT		L LAYOUT PLAN	
18-36 REHABILITATION	Sheet 3 Of	- 3	
CONNECTICUT	Projec† No. 179450289	Scale AS SHOWN	
	Drawing No.	Sheet	Revision
E.300-302_elec_plan.dwgHAB MLC HAB 21.04.07 Dwn. Chkd. Dsgn. YY.MM.DD	E.302	26 of 31	

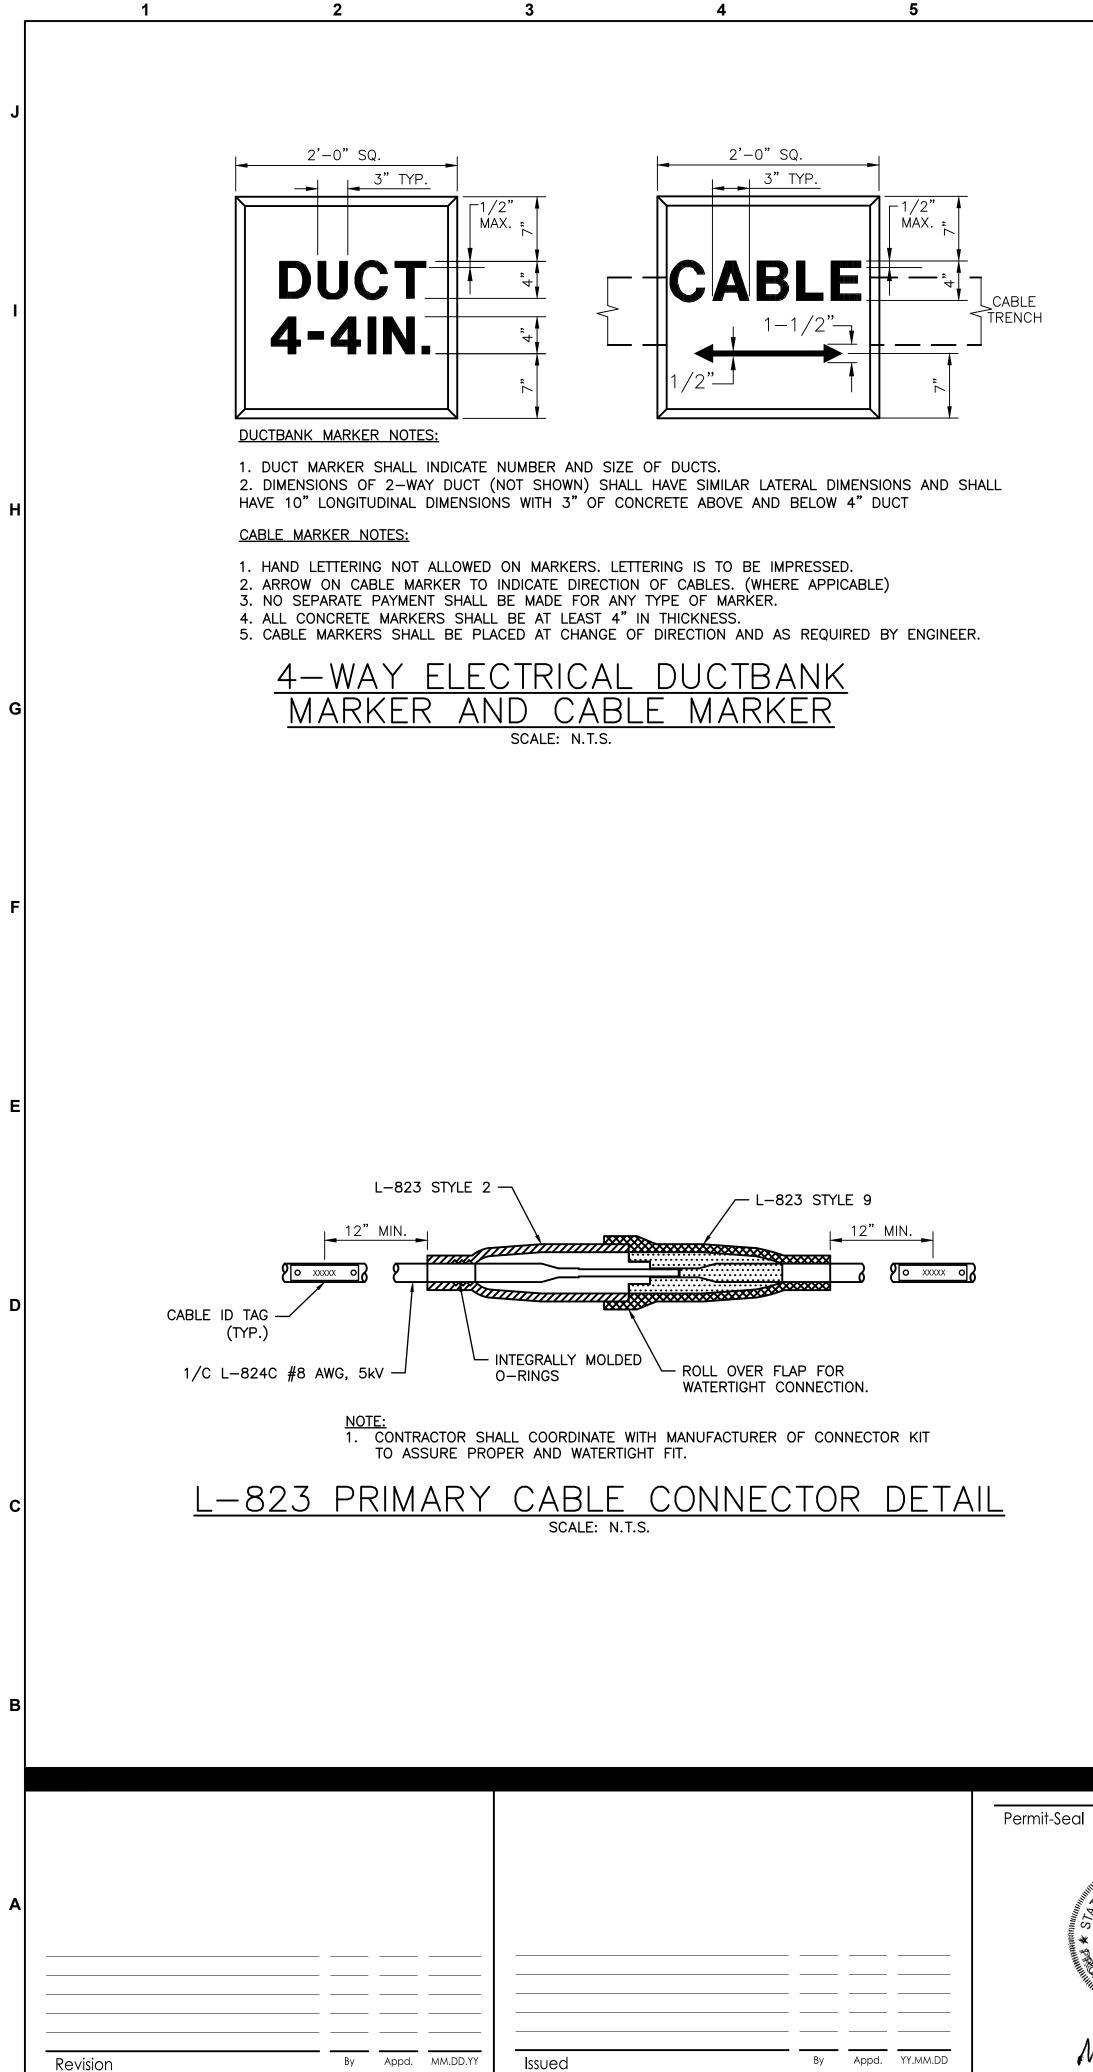

Issued

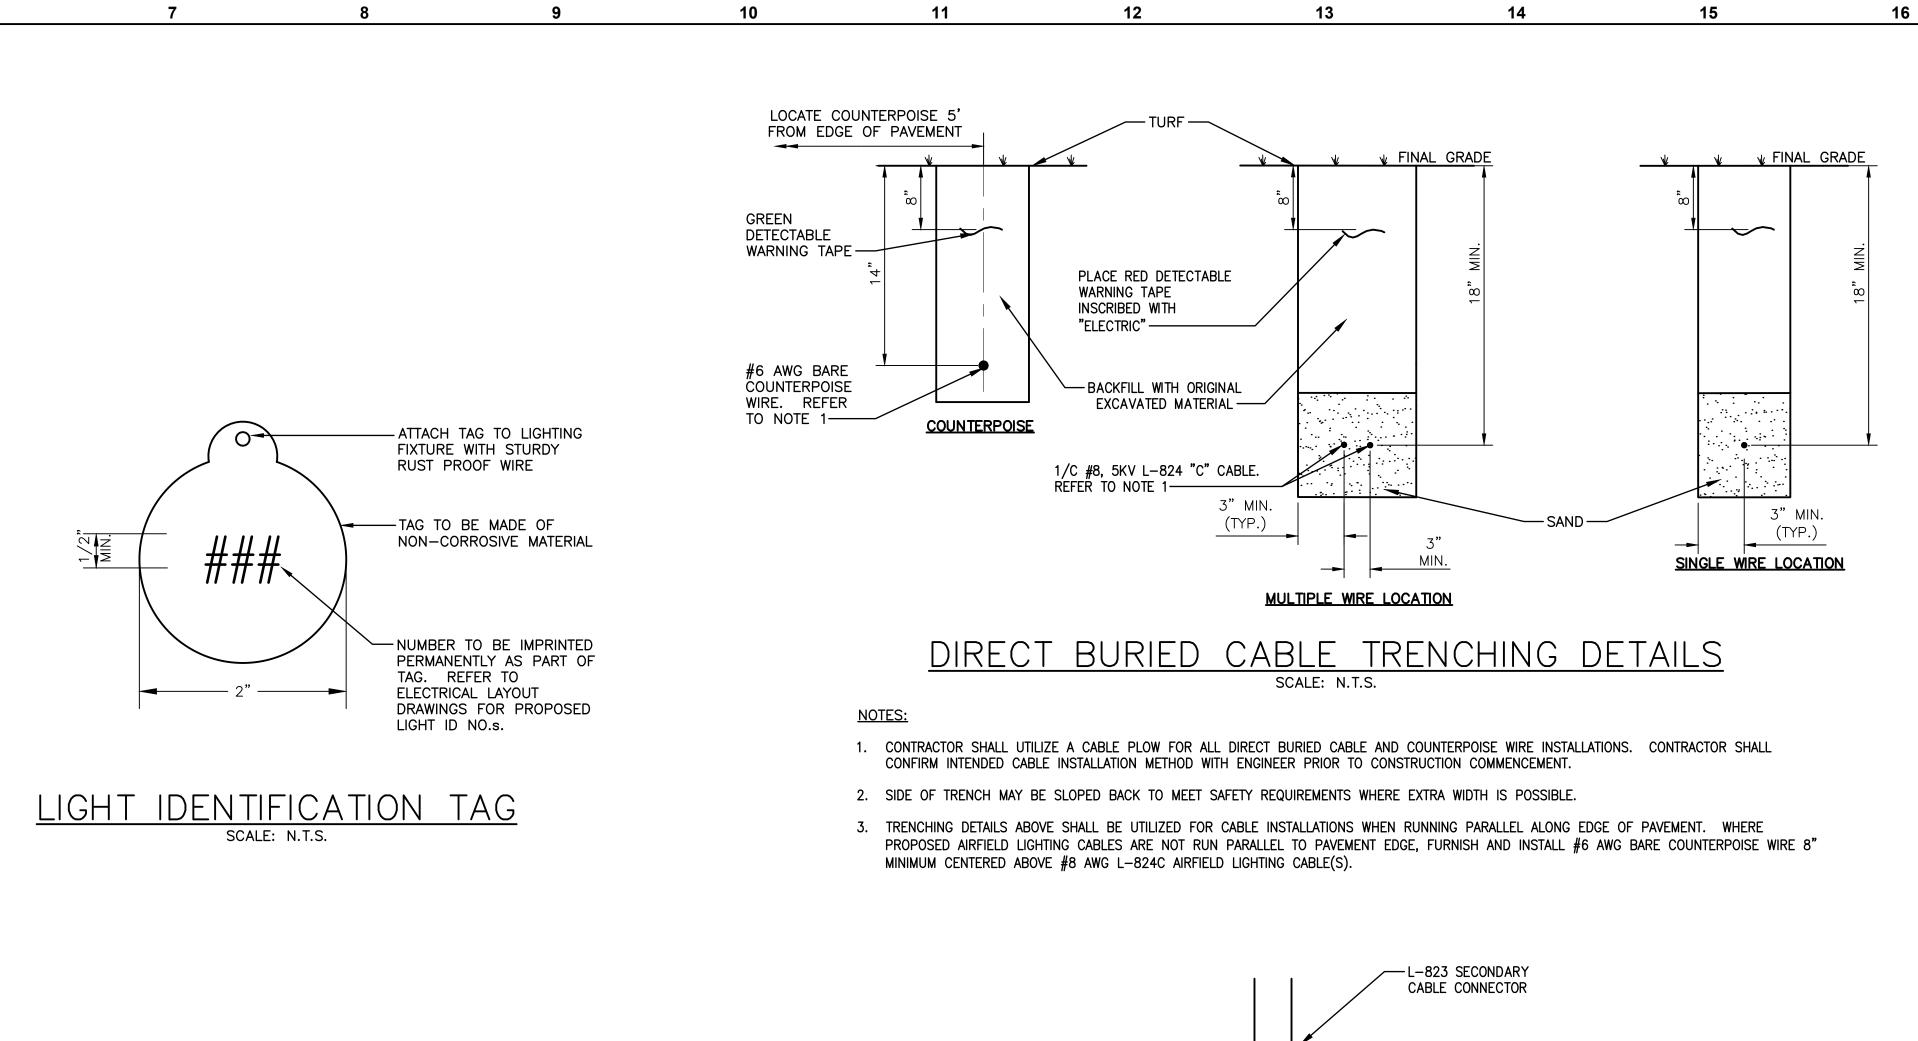

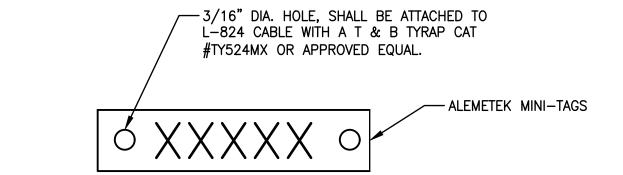

NOTE: 1. CONTRACTOR SHALL COORDINATE CABLE ID INSCRIPTION(S) WITH ENGINEER DURING EQUIPMENT SUBMITTAL TIMEFRAME PRIOR TO CONSTRUCTION. TO AND THE DEVELOPMENT OF CREDIT INDEX ON DRAWING E.001.




6

L-830 TRANSFORMER


\* - TAPE CONNECTOR WITH ELECTRICAL TAPE NOTE: 1. HEAT SHRINK TUBING SHALL NOT BE USED ON L-823 CONNECTORS



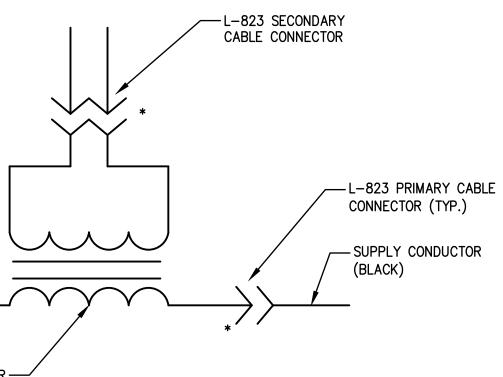



	Title	-	
MARKHAM MUNICIPAL AIRPORT	ELECTRICA	L DETAILS	
( 18-36 REHABILITATION	Sheet 1 Of	3	
CONNECTICUT	Project No. 179450289	Scale AS SHOWN	
	Drawing No.	Sheet	Revision
500-502_elec_dtls.dwg HAB MLC HAB 21.04.07 Dwn. Chkd. Dsgn. YY.MM.DD	E.500	27 of 31	

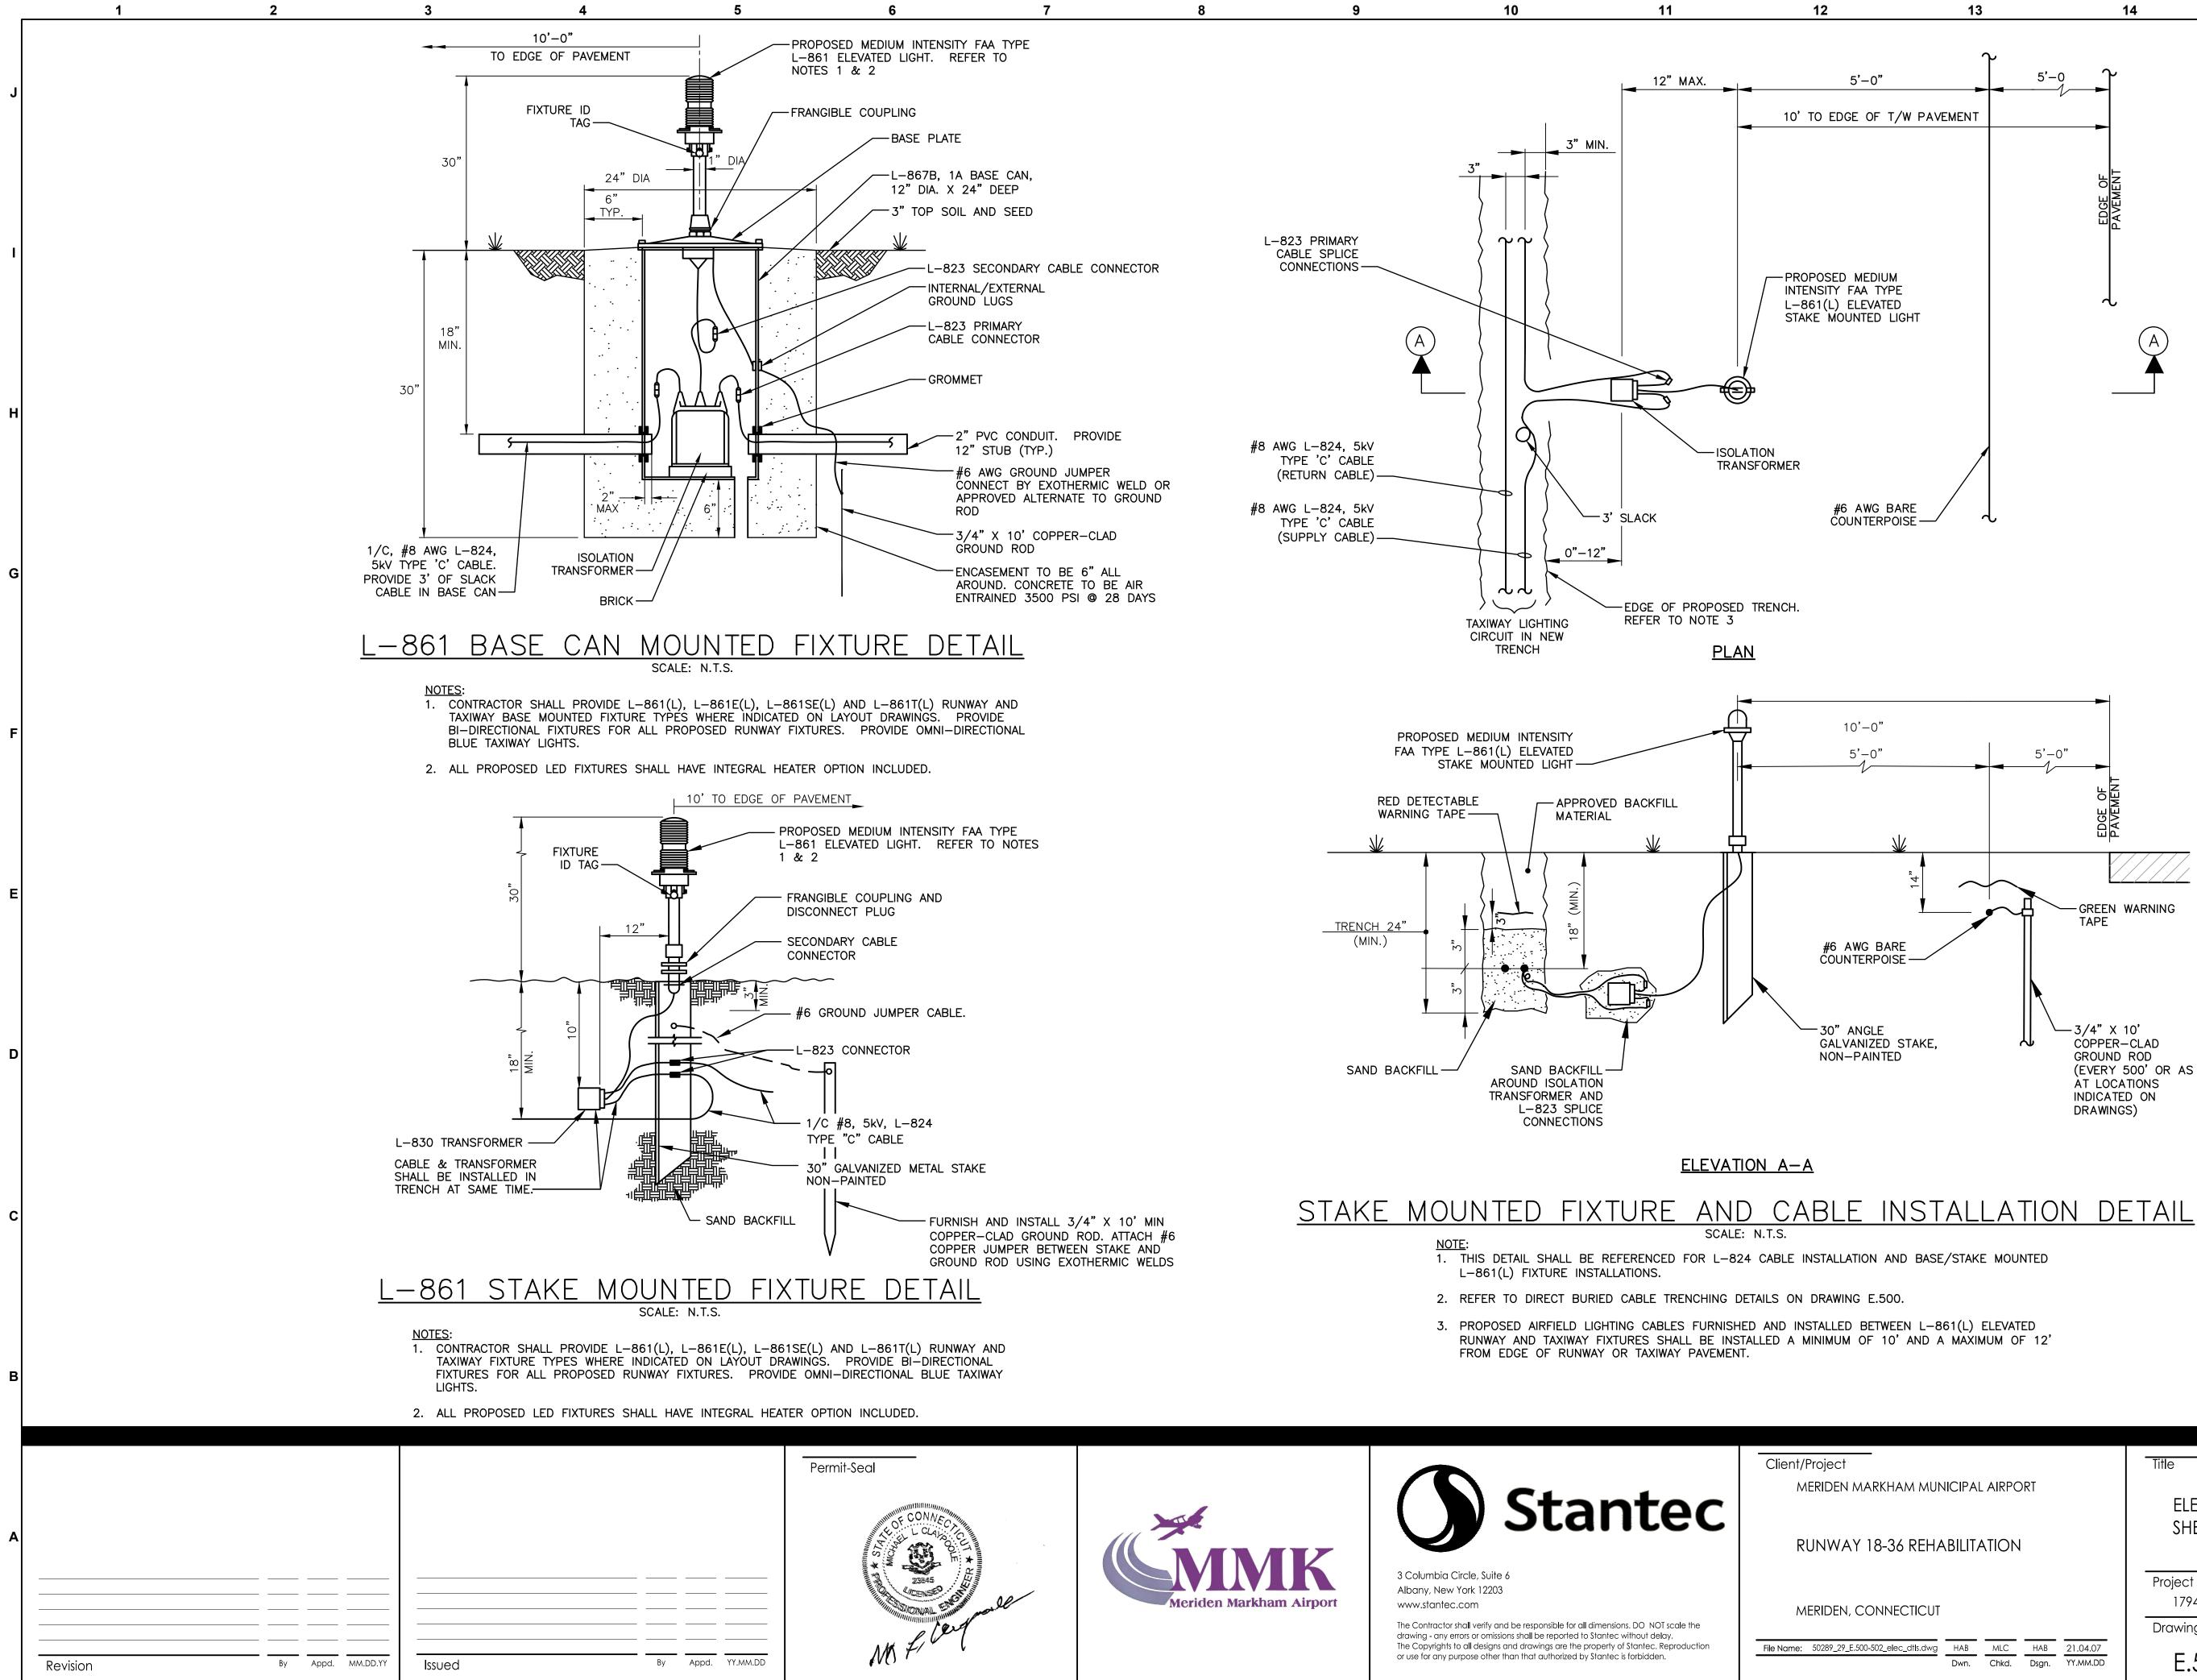





	Title		
ARKHAM MUNICIPAL AIRPORT	ELECTRICA	l Details	
18-36 REHABILITATION	Sheet 2 Of	3	
	Project No.	Scale	
CONNECTICUT	179450289	AS SHOWN	Devision
500-502_elec_dtls.dwg HAB MLC HAB 21.04.07	Drawing No.	Sheet	Revision
Dwn. Chkd. Dsgn. YY.MM.DD	E.501	28 of 31	

		SIGN SCHE	DULE	
SIGN NO	SIDE A	SIDE B	CCR ID	REMARKS
S1	A Y/B BL	A 18 Y/B W/R	RW	NEW LED, SIZE 1, STYLE 2, MOI
S2	←A→ B/Y	BL	TW	NEW LED, SIZE 1, STYLE 2, MOI
S3	A→ B/Y	BL	RW	NEW LED, SIZE 1, STYLE 2, MOI
S4	A FUEL→ Y/B B/Y	←FUEL A B/Y Y/B	TW	NEW LED, SIZE 1, STYLE 2, MOI
S5	BL	<mark>←D</mark> B/Y	RW	NEW LED, SIZE 1, STYLE 2, MOI
S6	←A→ B/Y	BL	TW	NEW LED, SIZE 1, STYLE 2, MOI
S7	D→ B/Y	BL	RW	NEW LED, SIZE 1, STYLE 2, MOI
S8	Y/B BL	<b>D 36-18</b> Y/B W/R	RW	NEW LED, SIZE 1, STYLE 2, MOI
S9	BL	<mark>←C</mark> <sub>B/Y</sub>	RW	NEW LED, SIZE 1, STYLE 2, MOI
S10	←A→ B/Y	BL	TW	NEW LED, SIZE 1, STYLE 2, MO
S11	C→ B/Y	BL	RW	NEW LED, SIZE 1, STYLE 2, MOI
S12	C Y/B BL	C 36-18 Y/B W/R	RW	NEW LED, SIZE 1, STYLE 2, MOI
S13	BL	<mark>←B</mark> B/Y	RW	NEW LED, SIZE 1, STYLE 2, MOI
S14	←A→ B/Y	BL	TW	NEW LED, SIZE 1, STYLE 2, MOI
S15	B→ B/Y	BL	RW	NEW LED, SIZE 1, STYLE 2, MOI
S16	Y/B BL	<b>B</b> 36-18 Y/B W/R	RW	NEW LED, SIZE 1, STYLE 2, MOI
S17	BL Y/B	A A→ Y/B B/Y	TW	NEW LED, SIZE 1, STYLE 2, MOI
S18	←A→ B/Y	BL	TW	NEW LED, SIZE 1, STYLE 2, MOI
S19	BL	←B B/Y	RW	NEW LED, SIZE 1, STYLE 2, MOI
S20	Y/B BL	A 36 Y/B W/R	RW	NEW LED, SIZE 1, STYLE 2, MO

3

4

5

BLANK


BL B/Y Y/B

BLACK SYMBOL ON YELLOW BACKGROUND YELLOW SYMBOL ON BLACK BACKGROUND

2


WHITE SYMBOL ON RED BACKGROUND W/R


								Permit-Seal
A		 				·		MICH AND A THINK
Revision	Ву	Appd.	MM.DD.YY	Issued	Ву	Appd.	YY.MM.DD	MS

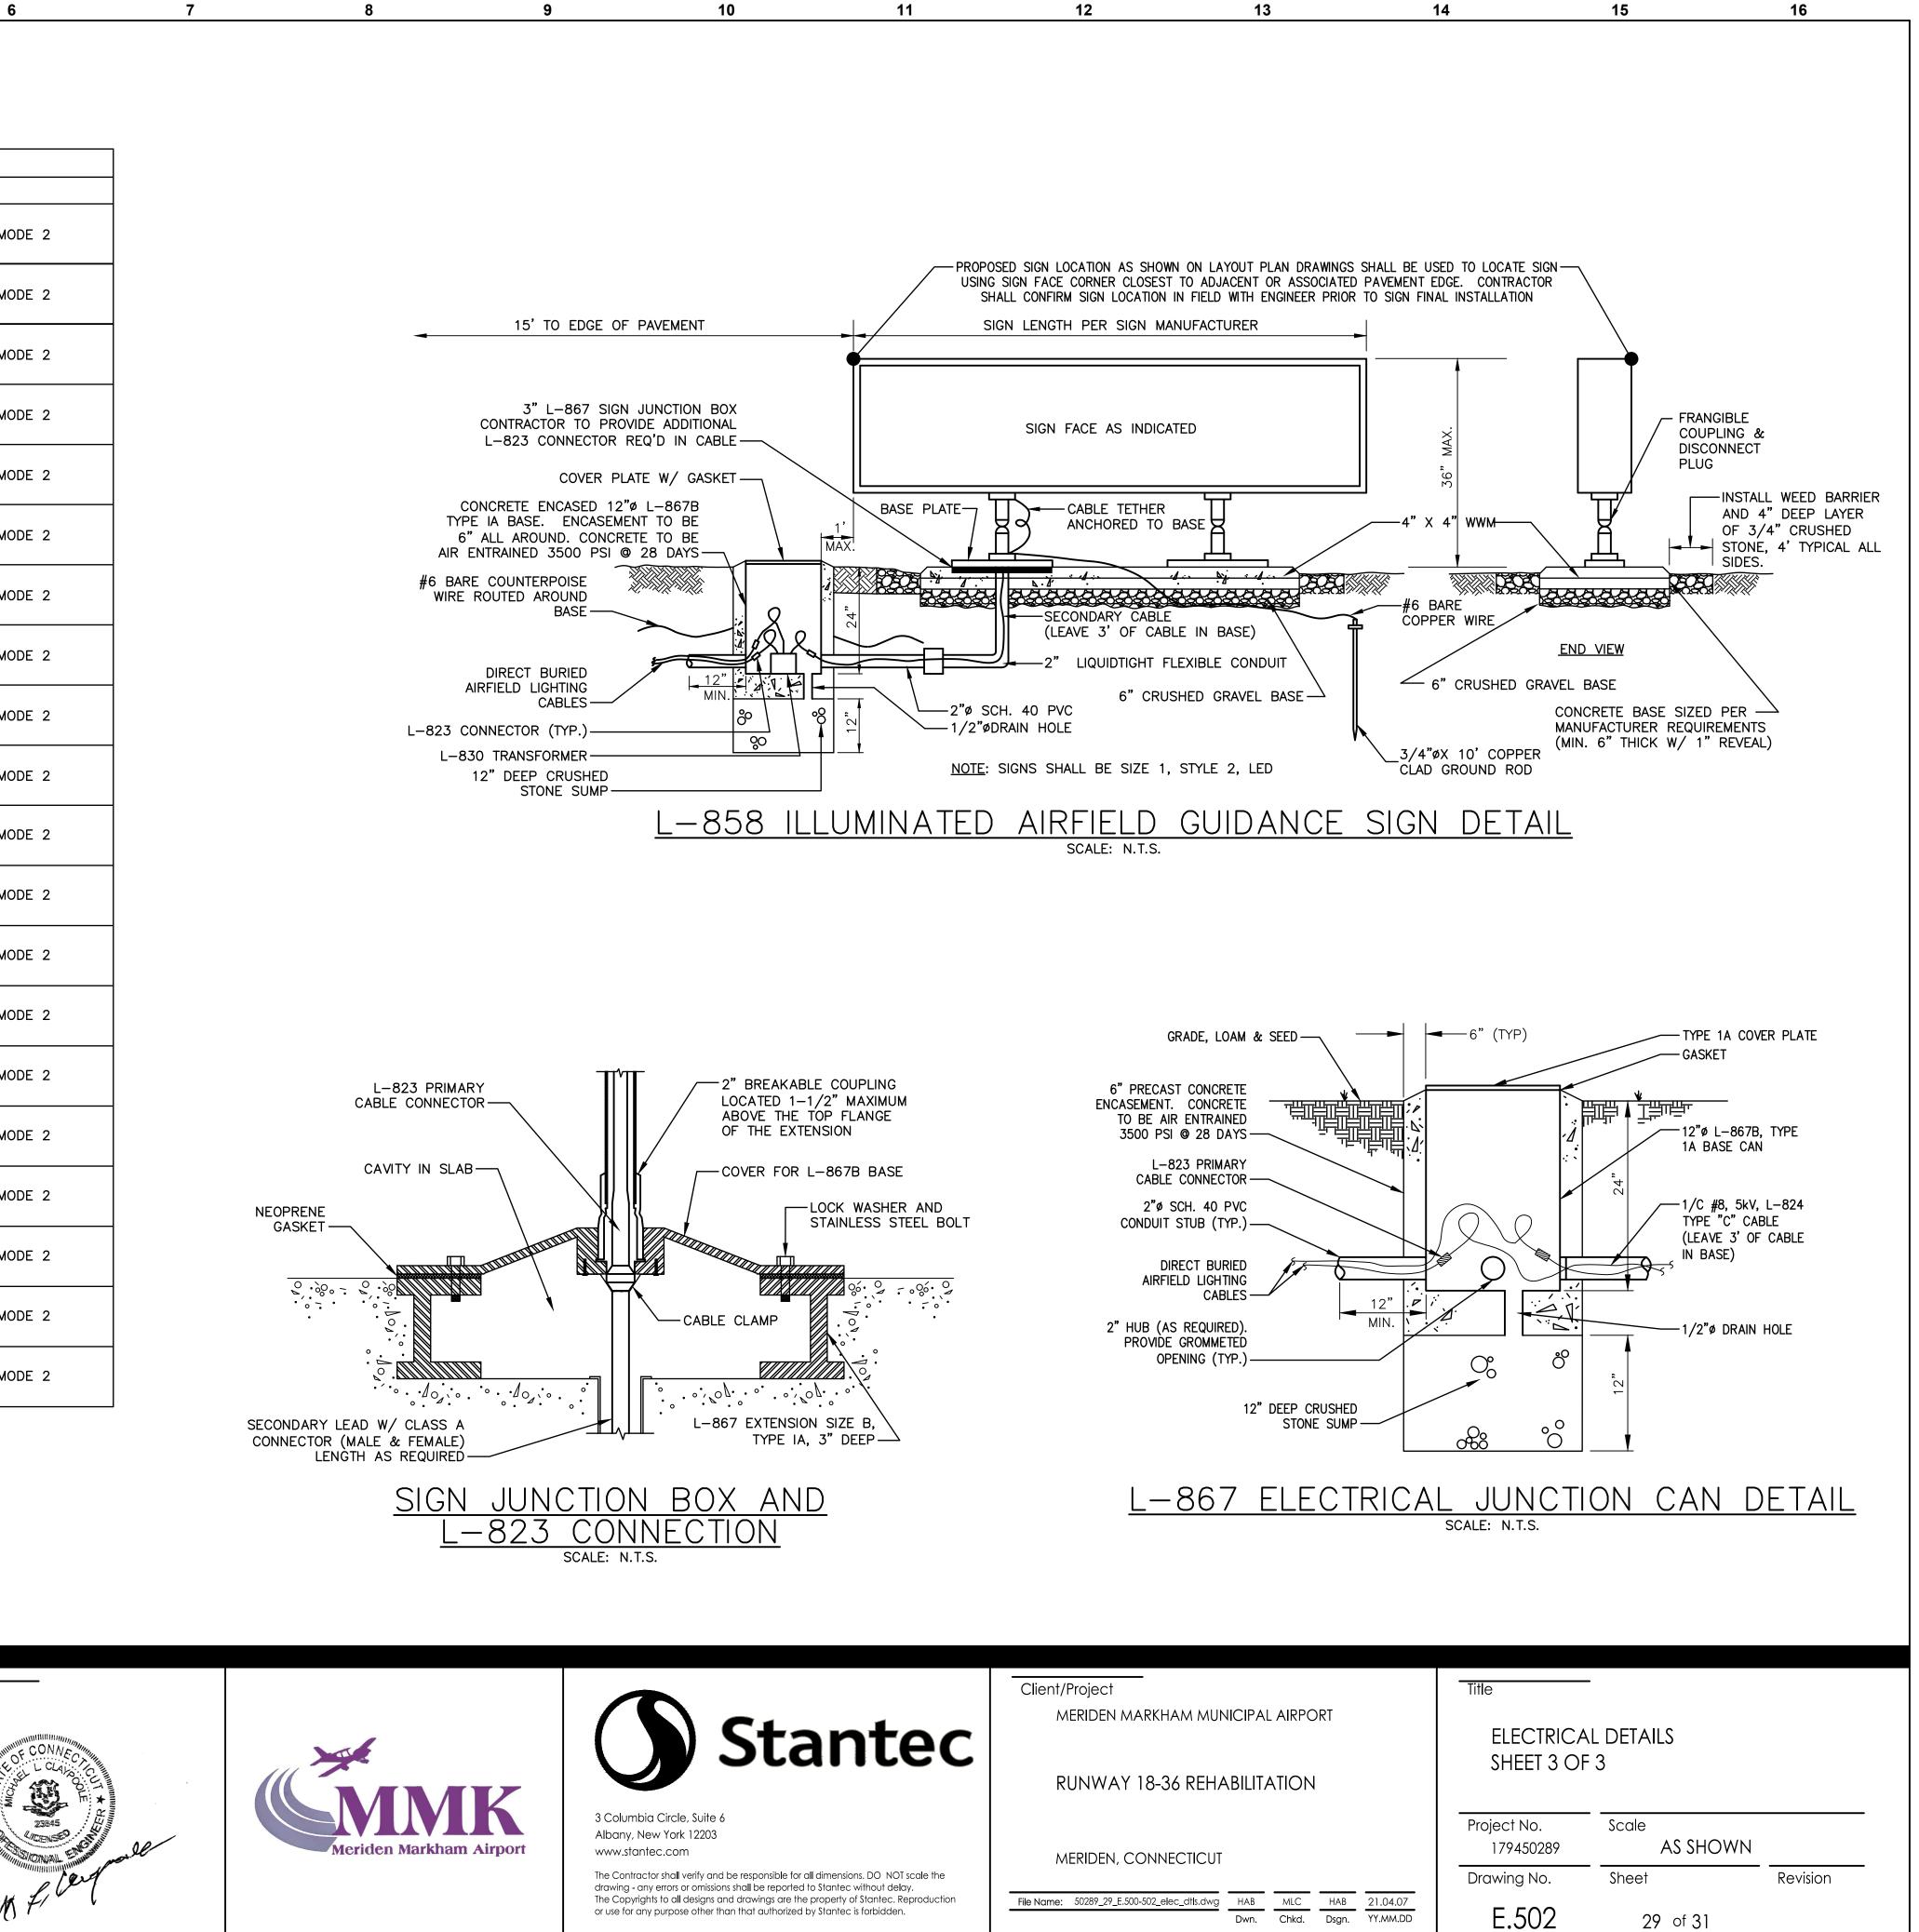



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Point Table					
Northing	Easting	Description			
745349.88	978636.16	TW A & TW B			
746302.66	978321.74	TW A & TW C			
747313.48	977988.16	TW A & TW D			
747599.91	977893.63	TW A & TW A NORTH			
745244.78	978686.64	MATCH EX.			
745290.63	978637.72	MATCH EX.			
745323.36	978622.80	TW FILLET			
745363.24	978609.64	TW FILLET			
745402.35	978601.95	MATCH EX.			
746236.06	978327.84	MATCH EX.			
746242.48	978325.76	TW FILLET			
746276.14	978308.37	TW FILLET			
746316.02	978295.21	TW FILLET			
746353.42	978289.15	TW FILLET			
746362.45	978285.98	MATCH EX.			
747243.33	977995.49	MATCH EX.			
747253.31	977992.22	TW FILLET			
747286.96	977974.80	TW FILLET			

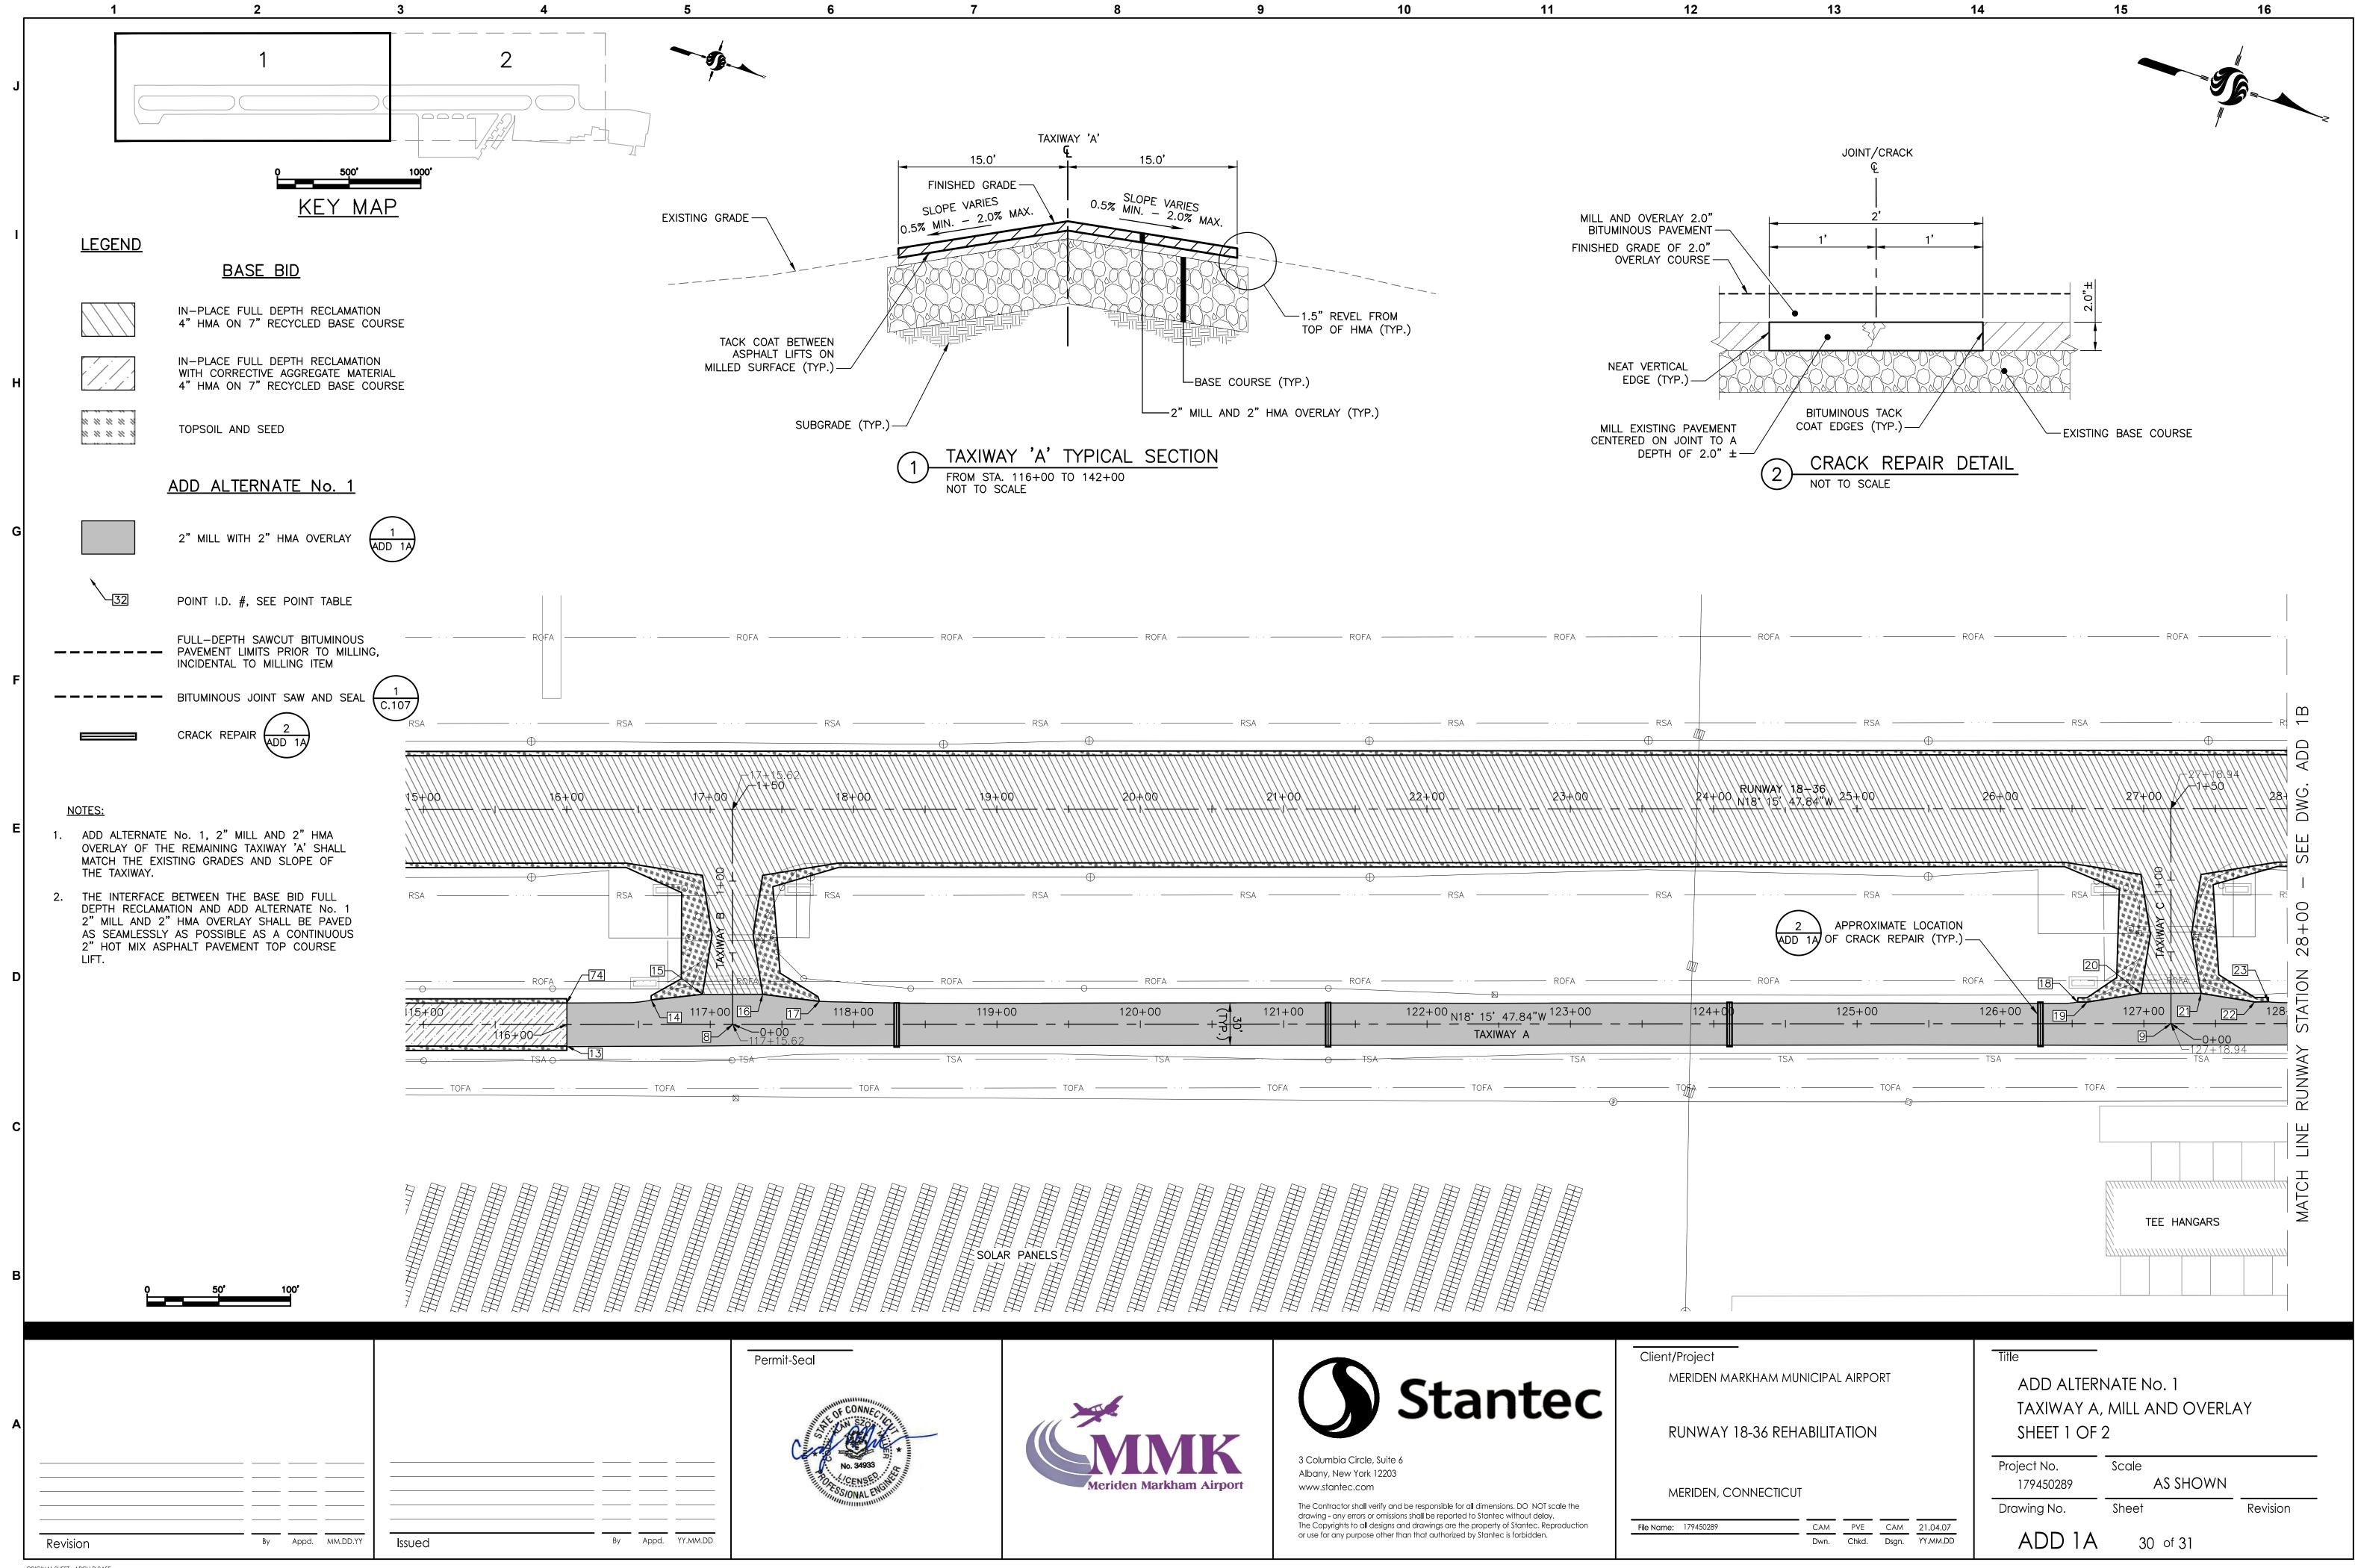Point Table				
Point #	Northing	Easting	Description	
28	747364.25	977955.61	TW FILLET	
29	747376.38	977952.00	MATCH EX.	
30	747527.71	977901.48	MATCH EX.	
31	747539.74	977897.69	TW FILLET	
32	747573.38	977880.27	TW FILLET	
33	747613.27	977867.11	TW FILLET	
34	747650.67	977861.08	TW FILLET	
35	747667.05	977855.66	MATCH EX.	
74	745235.38	978658.15	MATCH EX.	
76	746535.41	978260.74	MILLING LIMIT	
77	746896.56	978141.42	MILLING LIMIT	
78	747140.68	978060.91	MILLING LIMIT	
79	747713.83	977871.90	MILLING LIMIT	
80	747699.76	977844.66	MILLING LIMIT	

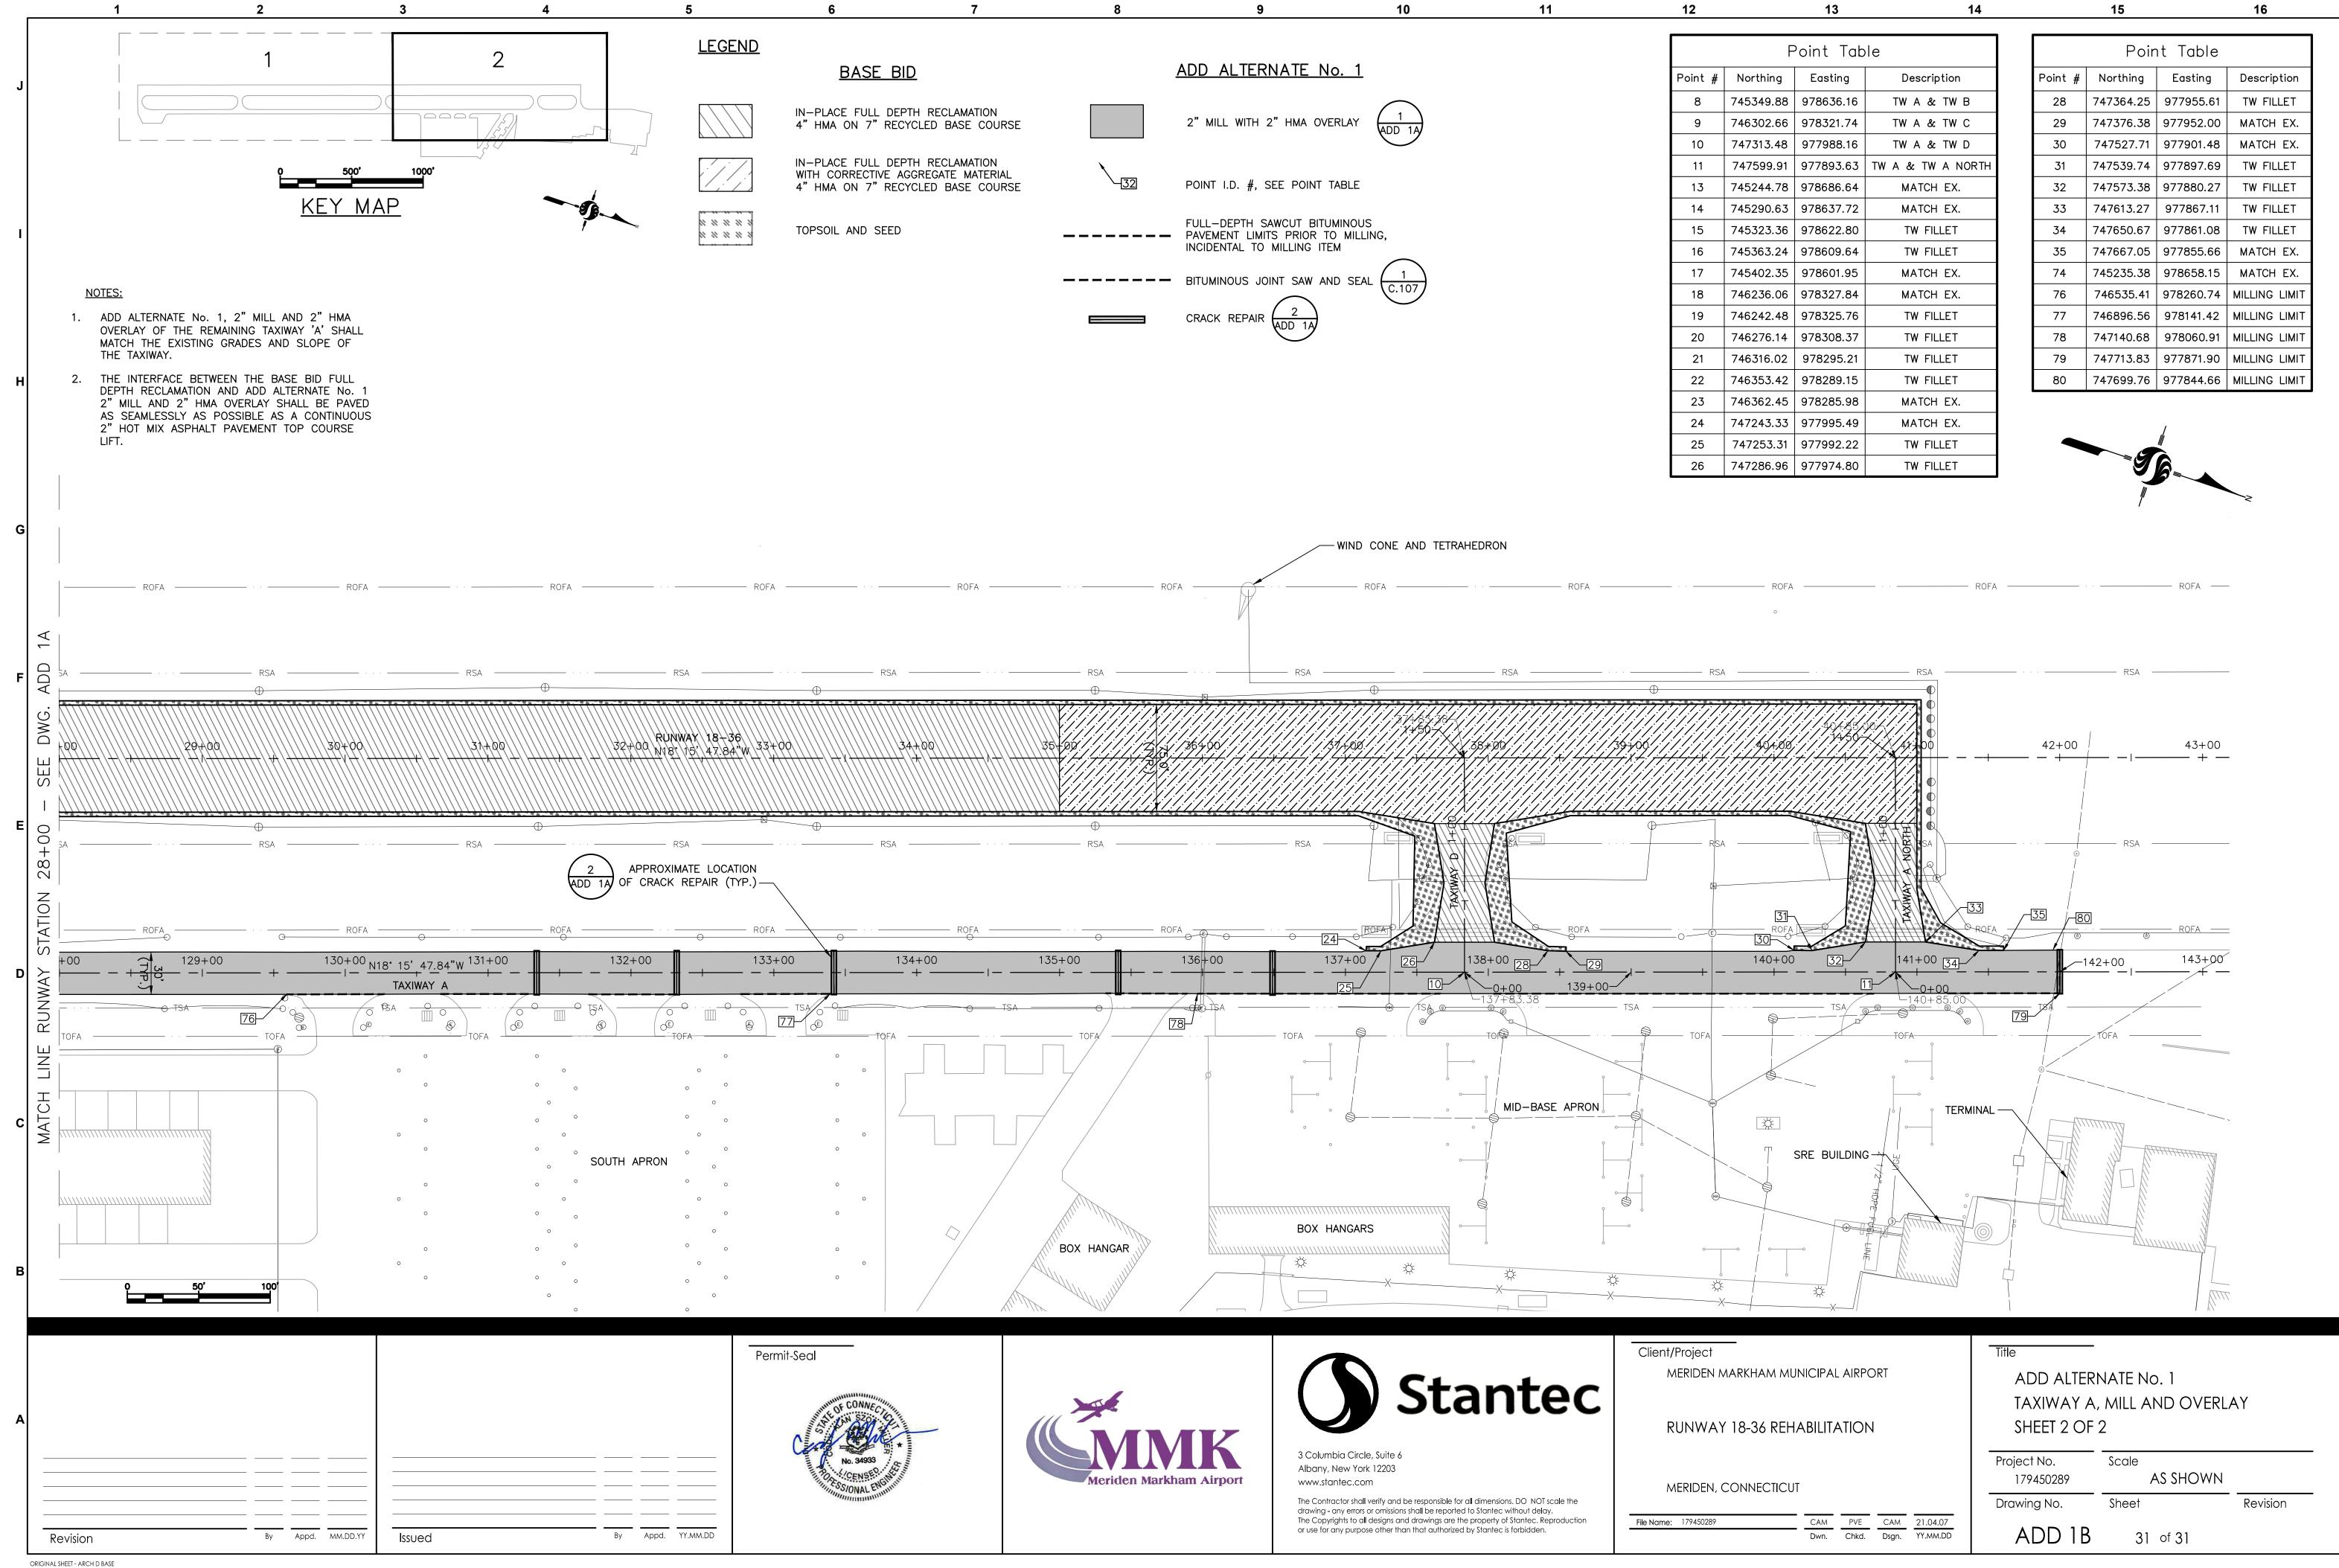